

SITE DATA

PROPERTY OWNER: ECHO FARM APARTMENTS, LLC
PROJECT ADDRESS: 4010 CAROLINA BEACH ROAD
PIN NUMBER: R06500-004-001-000 & R06500-004-001-002
ZONING DISTRICT: MF-M
FLOOD AREA: THE TRACT IS NOT WITHIN ANY SPECIAL FLOOD HAZARD BOUNDARY REFERENCE NC FIRM MAP #3720312500J...

Table with 5 columns: BUILDING, SQUARE FOOTAGE (1ST STORY), SQUARE FOOTAGE (2ND STORY), SQUARE FOOTAGE (3RD STORY), NUMBER OF UNITS (1 BEDROOM). Rows include buildings 1-2, 3-8, CLUBHOUSE, and MAINTENANCE.

TOTAL AMOUNT & PERCENT OF IMPERVIOUS SURFACE AREAS ON-SITE:

Table with 4 columns: BEFORE DEVELOPMENT (AREA (SF), % OF SITE), AFTER DEVELOPMENT (EX. (SF), PROPOSED (SF), TOTAL (SF), % OF SITE). Rows include BUILDINGS, DRIVEWAY, OTHER, and TOTAL.

OFF STREET PARKING CALCULATIONS (RESIDENTIAL):
MIN. PARKING REQ. = 1.5 SPACES/UNIT x 184 UNITS = 276 SPACES
MAX. PARKING REQ. = 2.5 SPACES/UNIT x 184 UNITS = 460 SPACES
NUMBER OF PROPOSED PARKING SPACES = 289

CITY OF WILMINGTON STANDARD NOTES:
1. PRIOR TO ANY CLEARING, GRADING OR CONSTRUCTION ACTIVITY, TREE PROTECTION FENCING WILL BE INSTALLED AROUND PROTECTED TREES OR GROVES OF TREES AND NO CONSTRUCTION WORKERS, TOOLS, MATERIALS, OR VEHICLES ARE PERMITTED WITHIN THE TREE PROTECTION FENCING.

1. PARKING AND LANDSCAPING CANNOT BLOCK FIRE HYDRANTS OR FDC'S. A 3-FOOT CLEAR SPACE SHALL BE MAINTAINED AROUND THE CIRCUMFERENCE OF THE HYDRANT AND FDC.
2. FIRE HYDRANTS CANNOT BE FURTHER THAN 8' FROM THE CURB.
3. NEW HYDRANTS MUST BE BROUGHT INTO SERVICE PRIOR TO COMBUSTIBLE MATERIALS BEING DELIVERED TO THE JOB SITE.

WATER & SEWER CAPACITY
EXISTING WATER CAPACITY: 2 HOUSES x 400 GPD/HOUSE = 800 GPD
EXISTING SEWER CAPACITY: 2 HOUSES x 360 GPD/HOUSE = 720 GPD
PROPOSED WATER CAPACITY: 184 UNITS x 400 GPD/UNIT + 50 PEOPLE x 10 GPD/PERSON = 74,100 GPD
PROPOSED SEWER CAPACITY: 184 UNITS x 240 GPD/UNIT + 50 PEOPLE x 10 GPD/PERSON = 44,660 GPD

1. SOIL TYPES: Jo (JOHNSTON), Le (LEON), Ly (LYNN HAVEN), & Kr (KUREB).
2. THIS SITE IS NOT LOCATED WITHIN A CAMA AEC (PER ECS CAROLINAS, LLP).
3. A 25' CONSERVATION SETBACK IS REQUIRED FROM THE WETLANDS WHICH IS CONSIDERED SWAMP FOREST (PER ECS CAROLINAS, LLP).

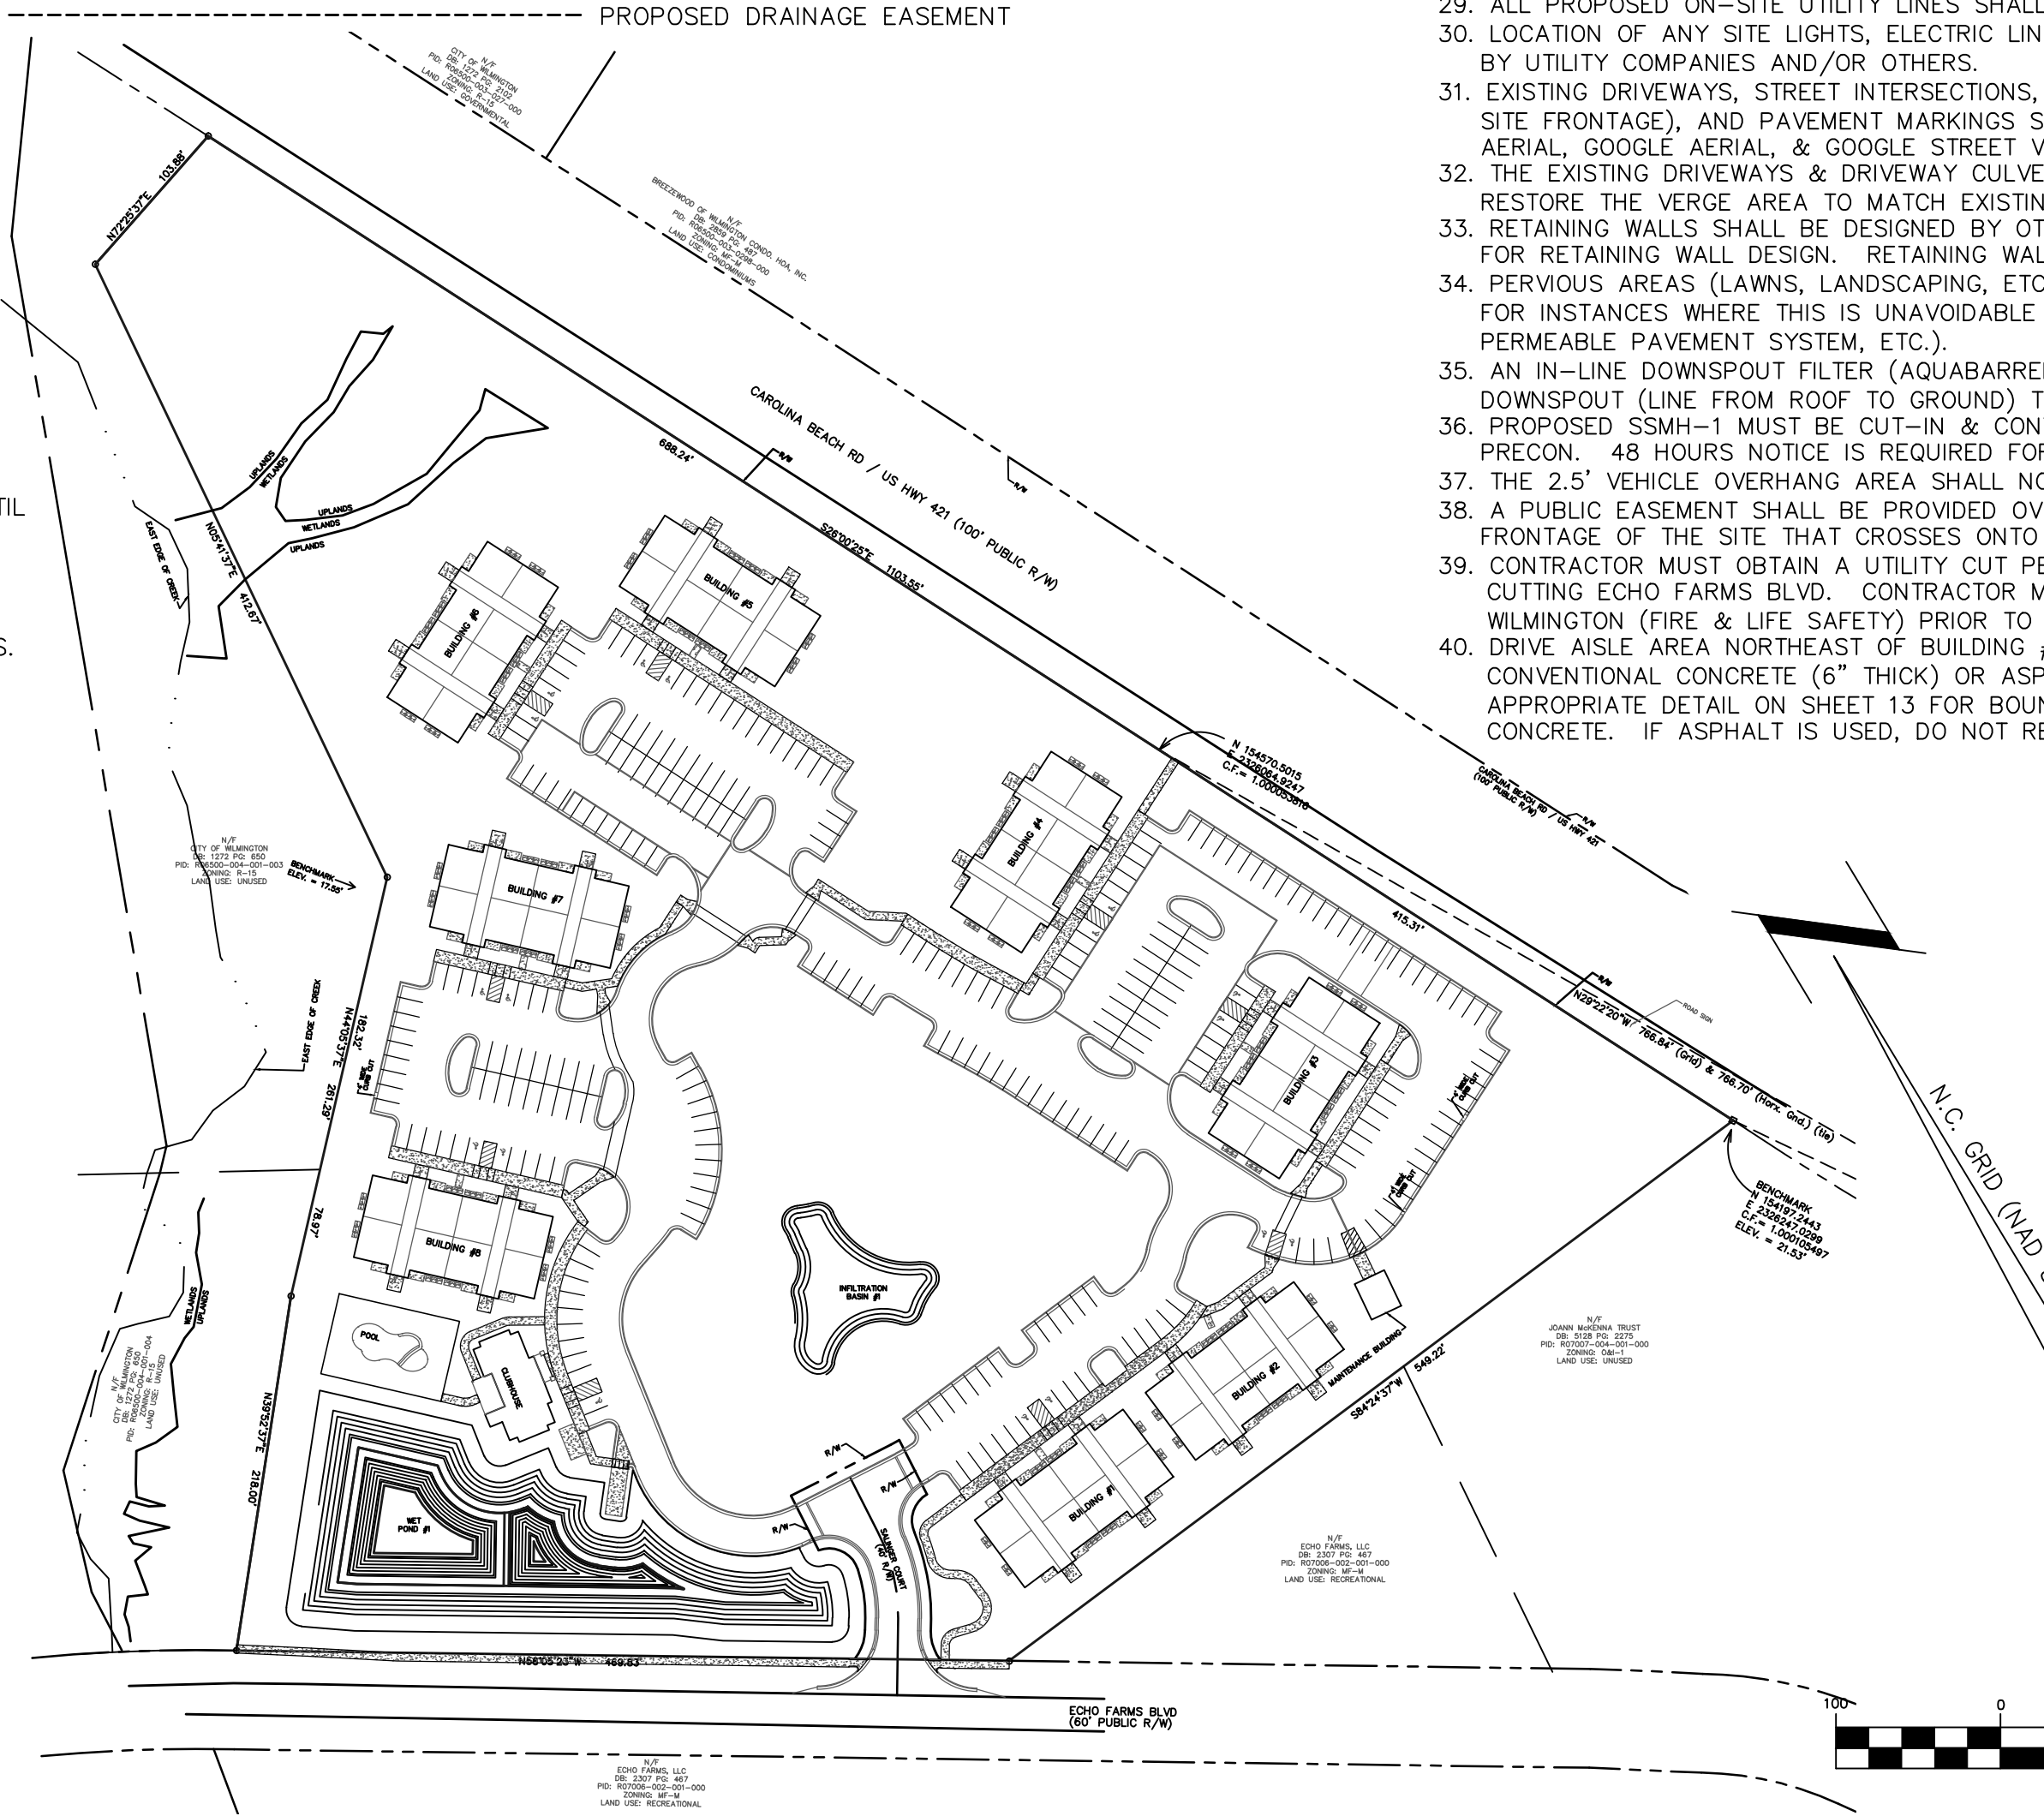
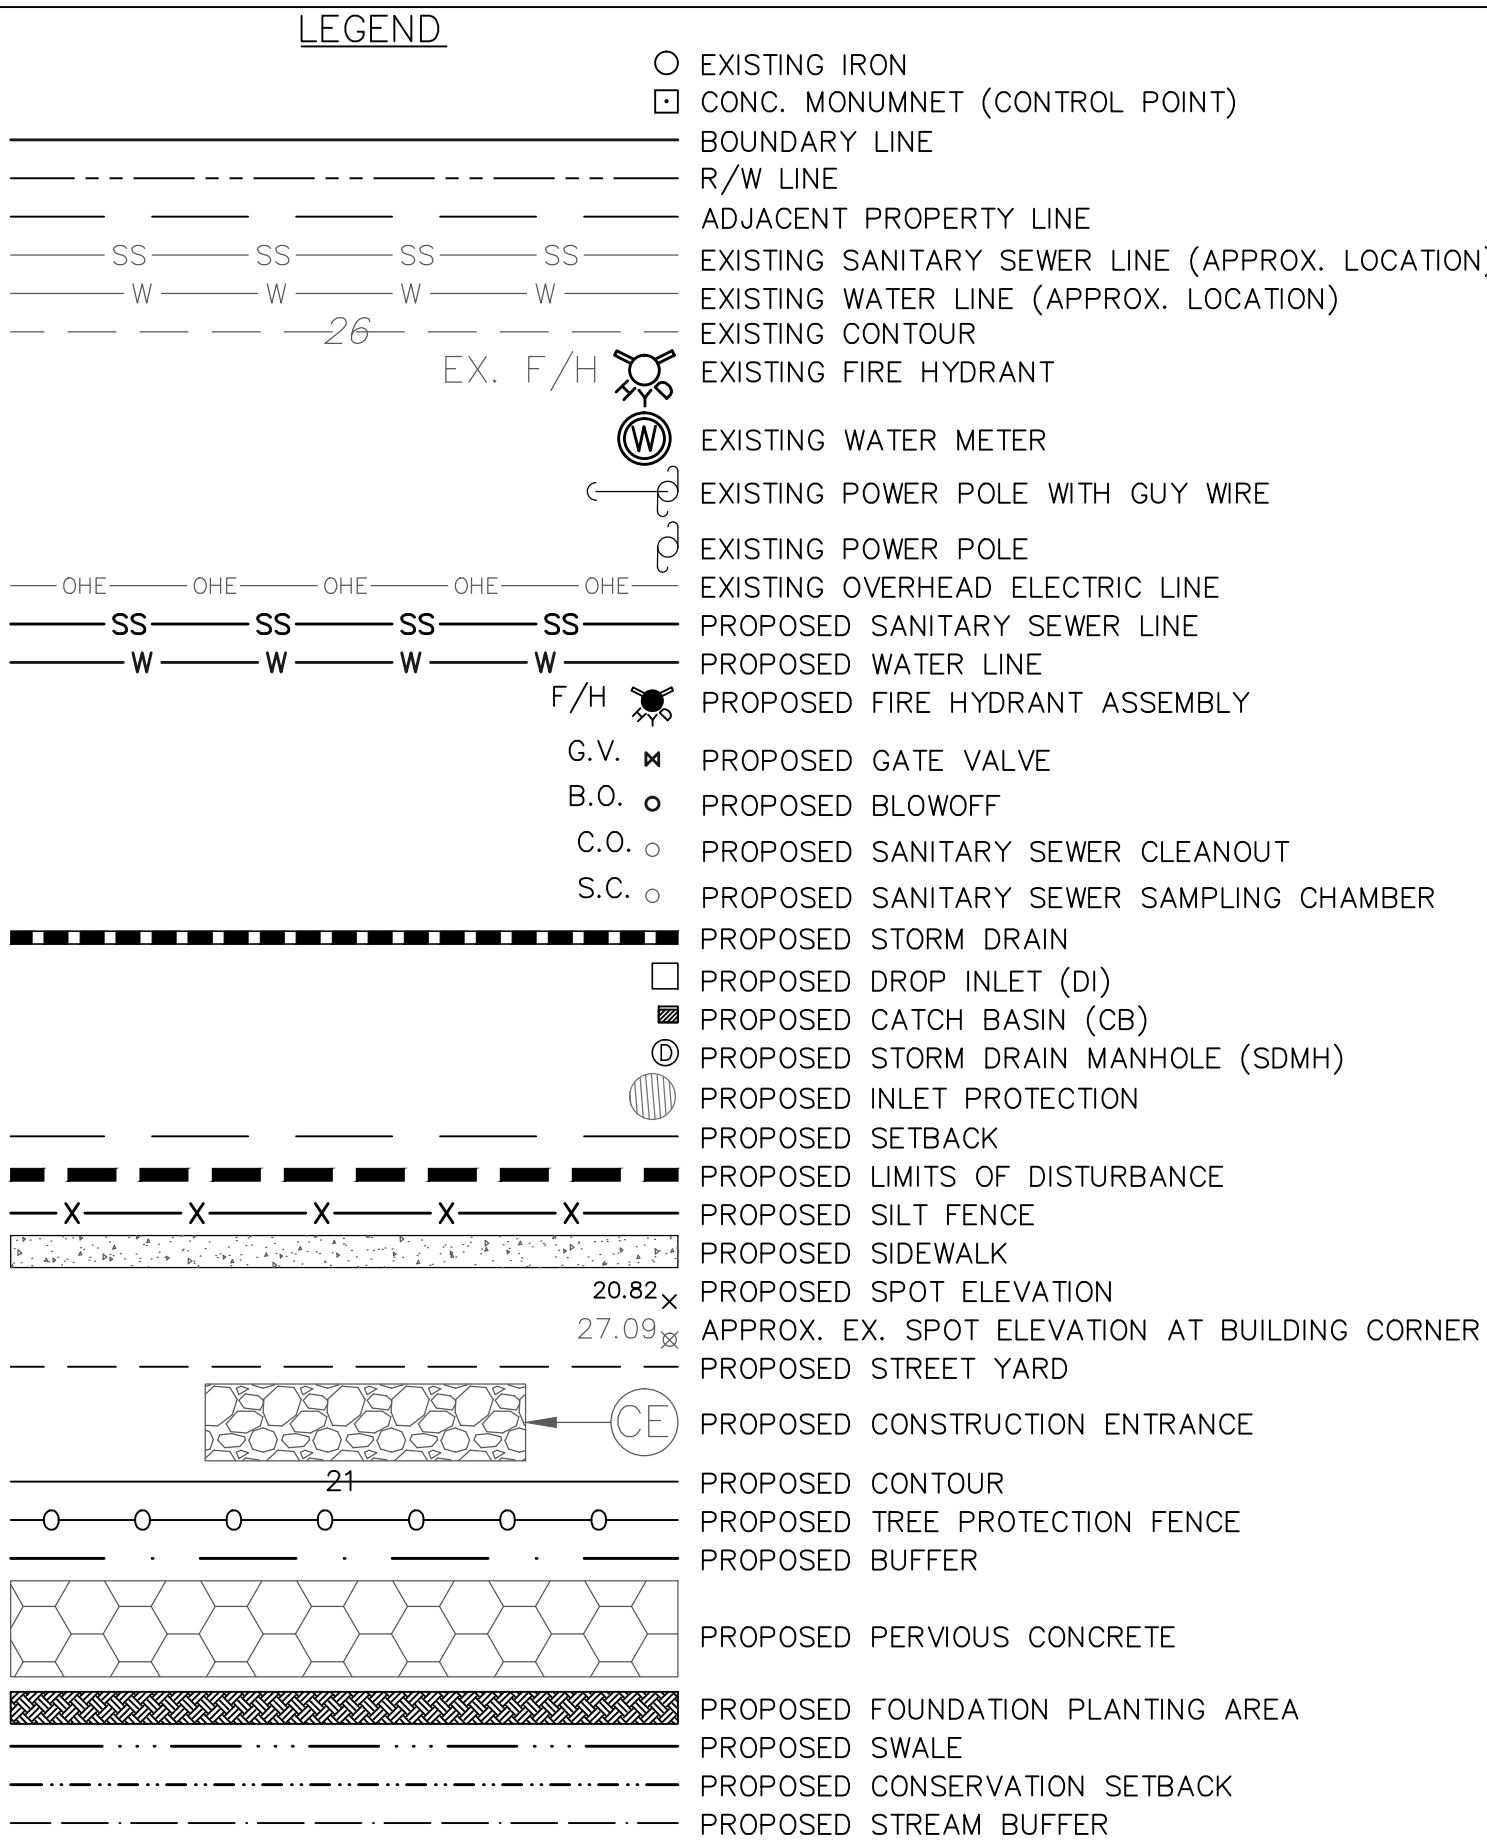


Table with 2 columns: Capacity Type and Value. Rows include Existing Water Capacity, Existing Sewer Capacity, Proposed Water Capacity, and Proposed Sewer Capacity.

TOTAL LENGTH OF PUBLIC SANITARY SEWER MAIN = 44.82 LF
TOTAL LENGTH OF PRIVATE SANITARY SEWER MAIN = 272.35 LF
TOTAL LENGTH OF PUBLIC WATER MAIN (DOMESTIC & FIRE LINE) = 38 LF
TOTAL LENGTH OF PRIVATE WATER LINE (DOMESTIC & FIRE LINE; INCLUDING LINES TO EACH BUILDING) = 4,354 LF

- NOTES:
1. BOUNDARY & TOPOGRAPHICAL SURVEY BY BATEMAN CIVIL SURVEY COMPANY, 200 N. MAIN STREET, HOLLY SPRINGS, NC 27540, PHONE: 919-577-1080.
2. ALL ELEVATIONS ARE IN FEET UNLESS OTHERWISE INDICATED.
3. ALL CITY, STATE, & FEDERAL REGULATIONS SHALL BE FOLLOWED.
4. PRIOR TO INSTALLATION OF WATER OR SANITARY SEWER MAINS CONTRACTOR SHALL NOTIFY THE ENGINEER WITH MALPASS ENGINEERING & SURVEYING, P.C. AT 910-392-5243.

Table with 2 columns: BUILDING and FFE (FEET). Rows include buildings 1, 2, 3-4, 5-6, 7, 8, CLUBHOUSE, and MAINTENANCE.

NOTE WELL: DEVELOPER TO PROVIDE SIDEWALK ALONG ECHO FARMS BLVD, IN ADDITION TO PROPOSED FRONTAGE SIDEWALK, IN LIEU OF PROVIDING FRONTAGE SIDEWALK ALONG CAROLINA BEACH ROAD PER PLANNING COMMISSION CONDITIONAL APPROVAL.

OPEN SPACE: TOP OF STORMWATER POND AREA = 22,178 SF
REQUIRED OPEN SPACE = 0.35 * (475,805 - 22,178) = 158,769 SF = 3.64 ACRES
PROVIDED OPEN SPACE (INCLUDES ACTIVE & PASSIVE RECREATION AREA) = 160,238 SF = 3.68 ACRES

REQUIRED ACTIVE OR PASSIVE RECREATION AREA = 0.5 * 158,769 = 79,385 SF = 1.82 ACRES
PROVIDED ACTIVE RECREATION AREA = 6,072 SF = 0.14 ACRES
PROVIDED PASSIVE RECREATION AREA = 80,725 SF = 1.85 ACRES
PROVIDED TOTAL RECREATION AREA = 86,797 SF = 1.99 ACRES


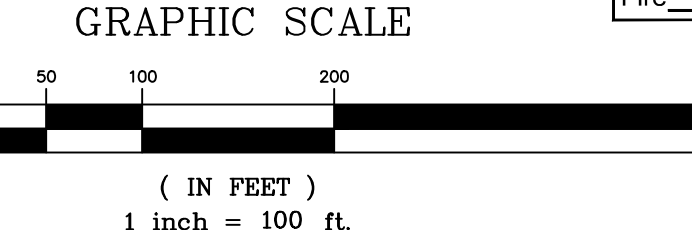


Table with 2 columns: REV NO. and DESCRIPTION. Rows include revisions for SRB submittal, erosion control, private street, preliminary bid, and other project updates.

Approved Construction Plan form with fields for Name, Date, Planning, Traffic, and Fire.

APPROVED STORMWATER MANAGEMENT PLAN form with fields for Date, Permit #, and Signature.



Project information block including: COVER SHEET (ECHO FARM APARTMENTS), DRAWN: JCB, CHECKED: JEM, PROJECT NO: 260, DEVELOPER: ECHO FARM APARTMENTS, LLC, MALPASS ENGINEERING & SURVEYING, P.C. logo and contact info, and SHEET NO: 1 OF 22.

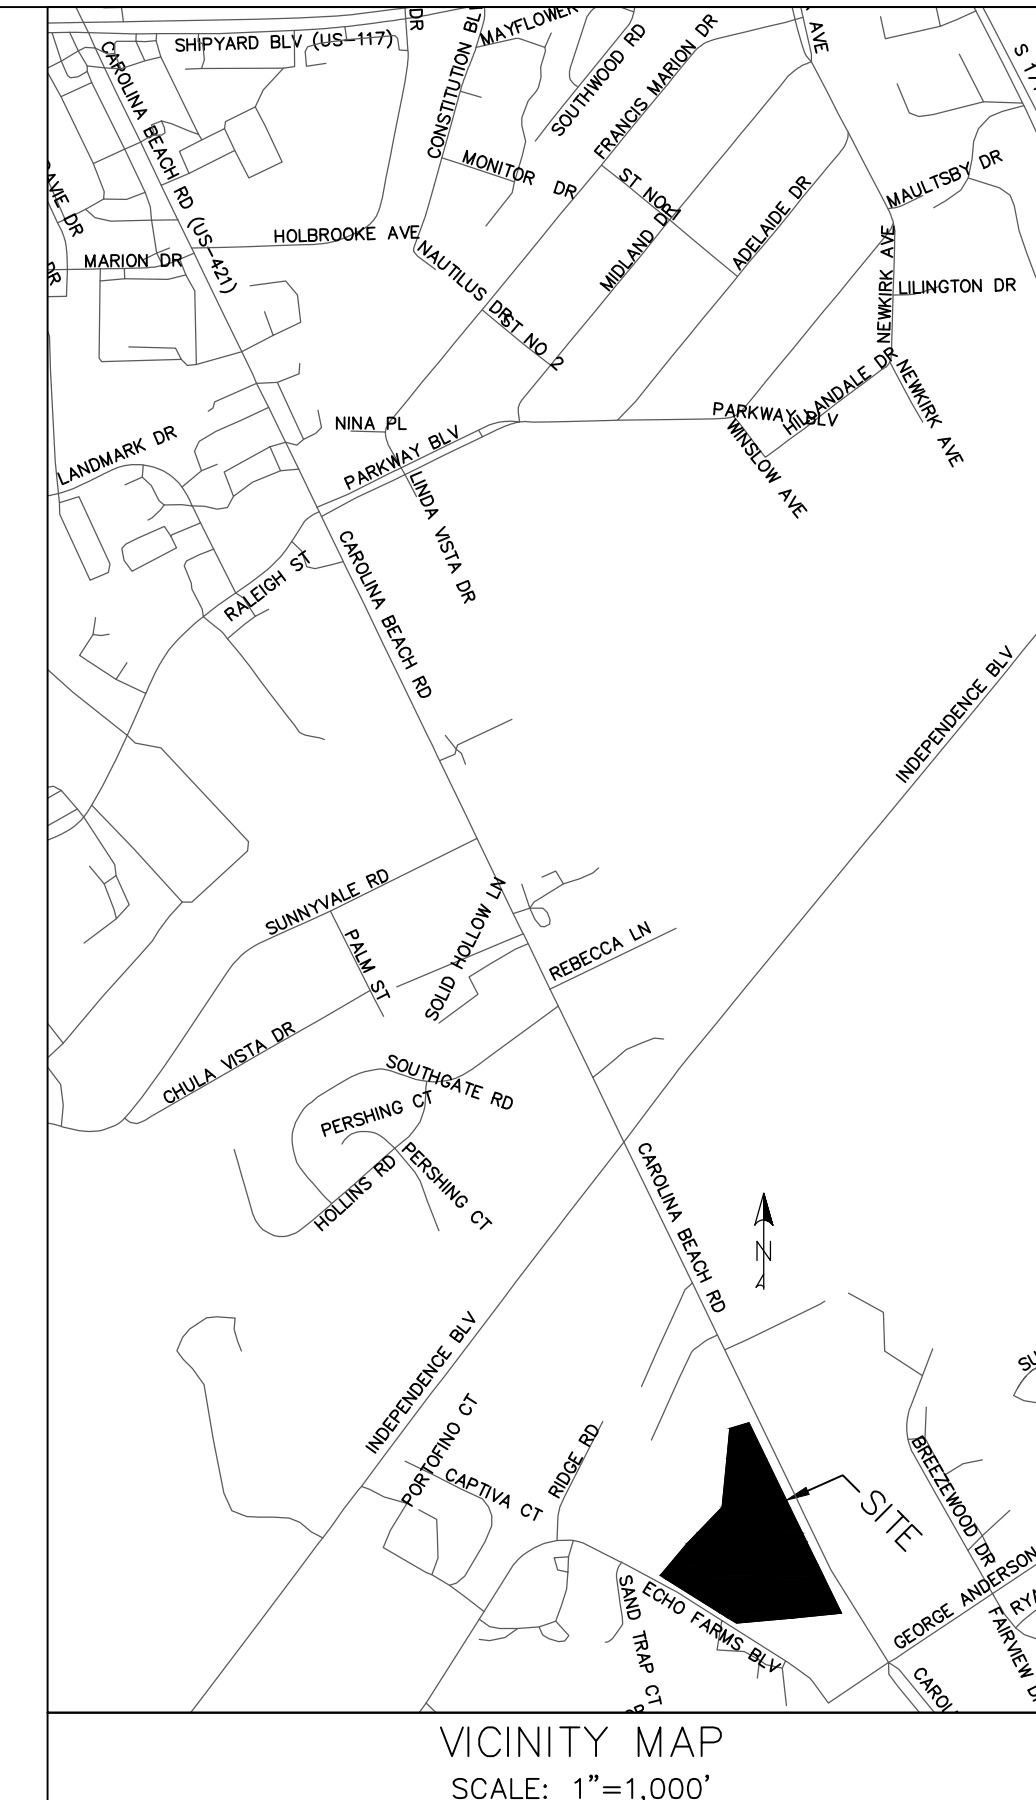

SHEET INDEX: Table listing sheet numbers and titles from 1 to 22, including COVER SHEET, TREE PROTECTION, EROSION CONTROL, and various utility and detail sheets.

MATCHLINE
SEE SHEET 4

MATCHLINE
SEE SHEET 4

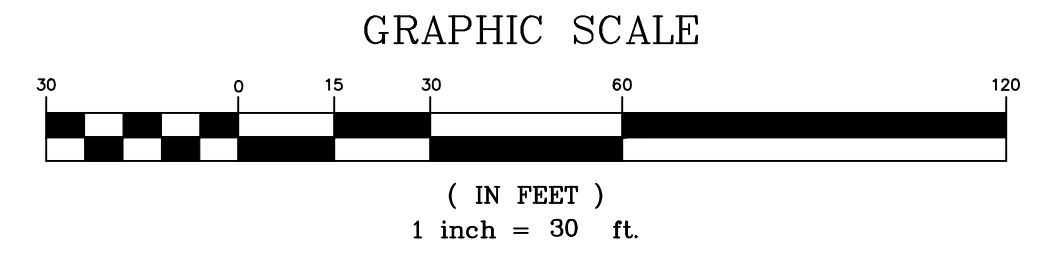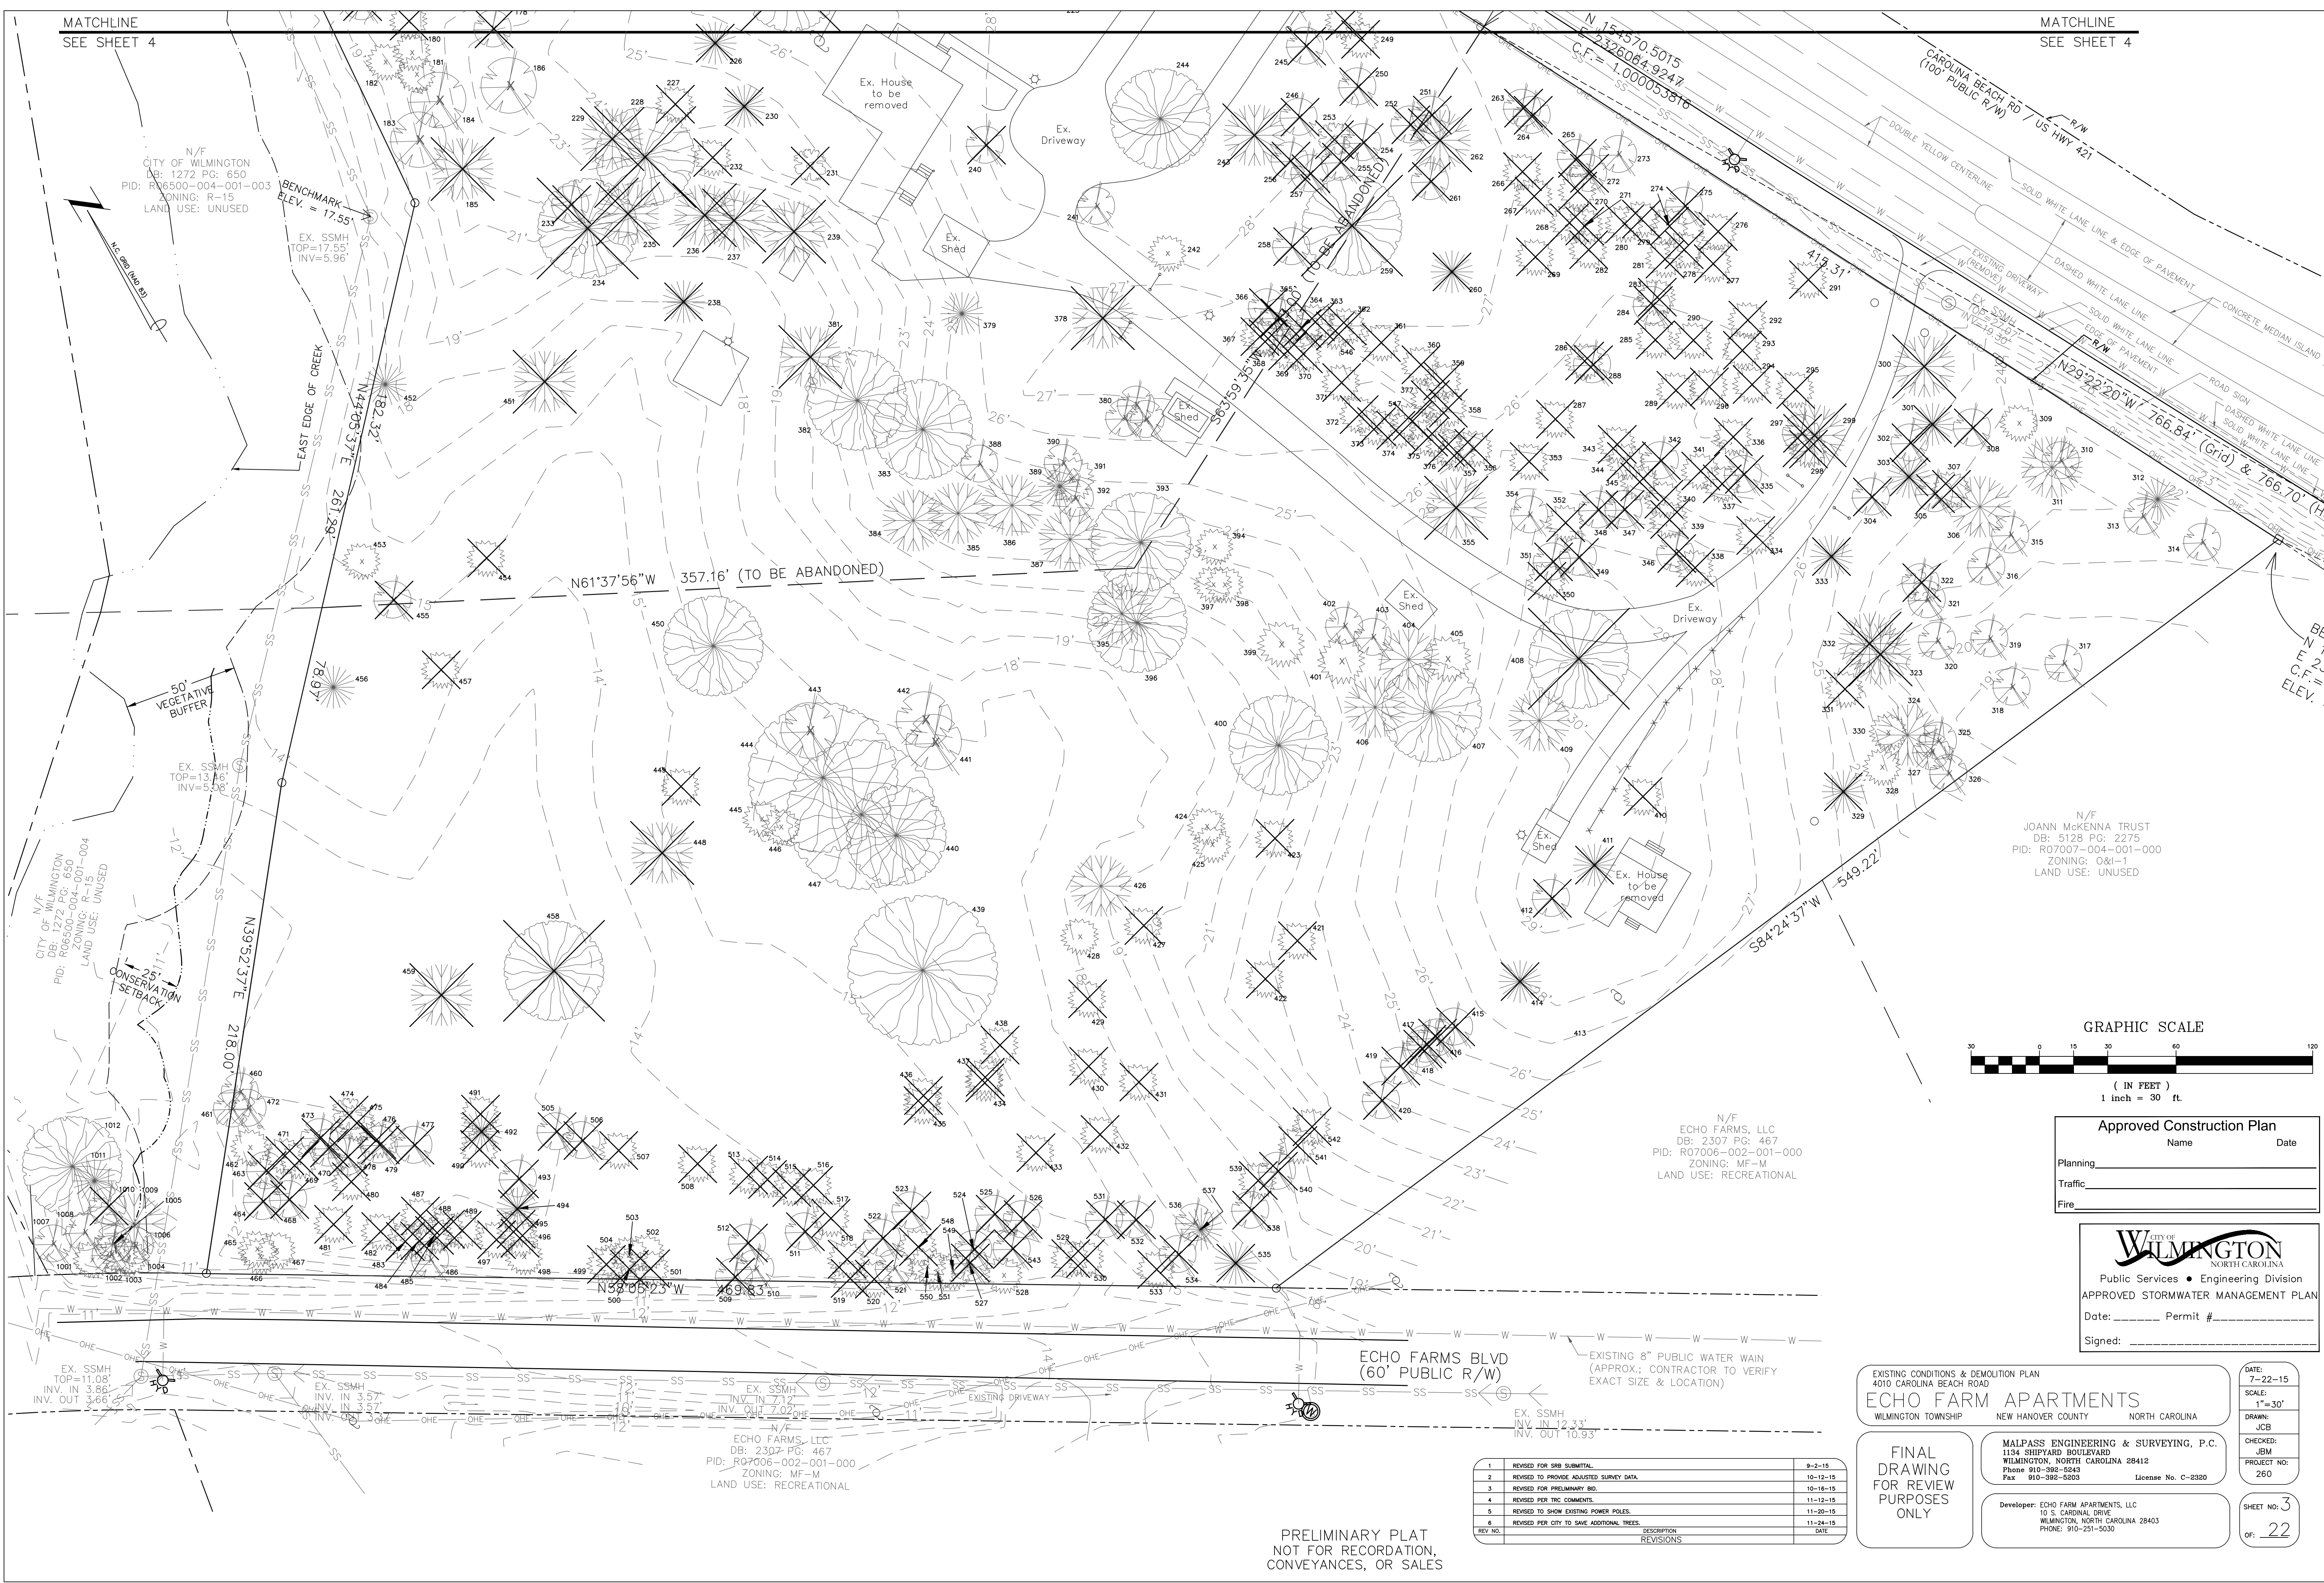

Approved Construction Plan

Name	Date
Planning	
Traffic	
Fire	

CITY OF WILMINGTON
 NORTH CAROLINA
 Public Services • Engineering Division
 APPROVED STORMWATER MANAGEMENT PLAN
 Date: _____ Permit # _____
 Signed: _____

EXISTING CONDITIONS & DEMOLITION PLAN
 4010 CAROLINA BEACH ROAD
ECHO FARM APARTMENTS
 WILMINGTON TOWNSHIP NEW HANOVER COUNTY NORTH CAROLINA

FINAL DRAWING FOR REVIEW PURPOSES ONLY


MALPASS ENGINEERING & SURVEYING, P.C.
 1134 SHIPYARD BOULEVARD
 WILMINGTON, NORTH CAROLINA 28412
 Phone 910-392-6243
 Fax 910-392-5203 License No. C-2320

Developer: ECHO FARM APARTMENTS, LLC
 10 S. CARDINAL DRIVE
 WILMINGTON, NORTH CAROLINA 28403
 PHONE: 910-251-5030

DATE: 7-22-15
 SCALE: 1"=30'
 DRAWN: JCB
 CHECKED: JEM
 PROJECT NO: 260
 SHEET NO: 3
 OF: 22

REV. NO.	DESCRIPTION	DATE
1	REVISED FOR SRB SUBMITTAL.	8-2-15
2	REVISED TO PROVIDE ADJUSTED SURVEY DATA.	10-12-15
3	REVISED FOR PRELIMINARY RIB.	10-14-15
4	REVISED PER TRC COMMENTS.	11-13-15
5	REVISED TO SHOW EXISTING POWER POLES.	11-20-15
6	REVISED PER CITY TO SAVE ADDITIONAL TREES.	11-24-15

PRELIMINARY PLAT
 NOT FOR RECORDATION,
 CONVEYANCES, OR SALES

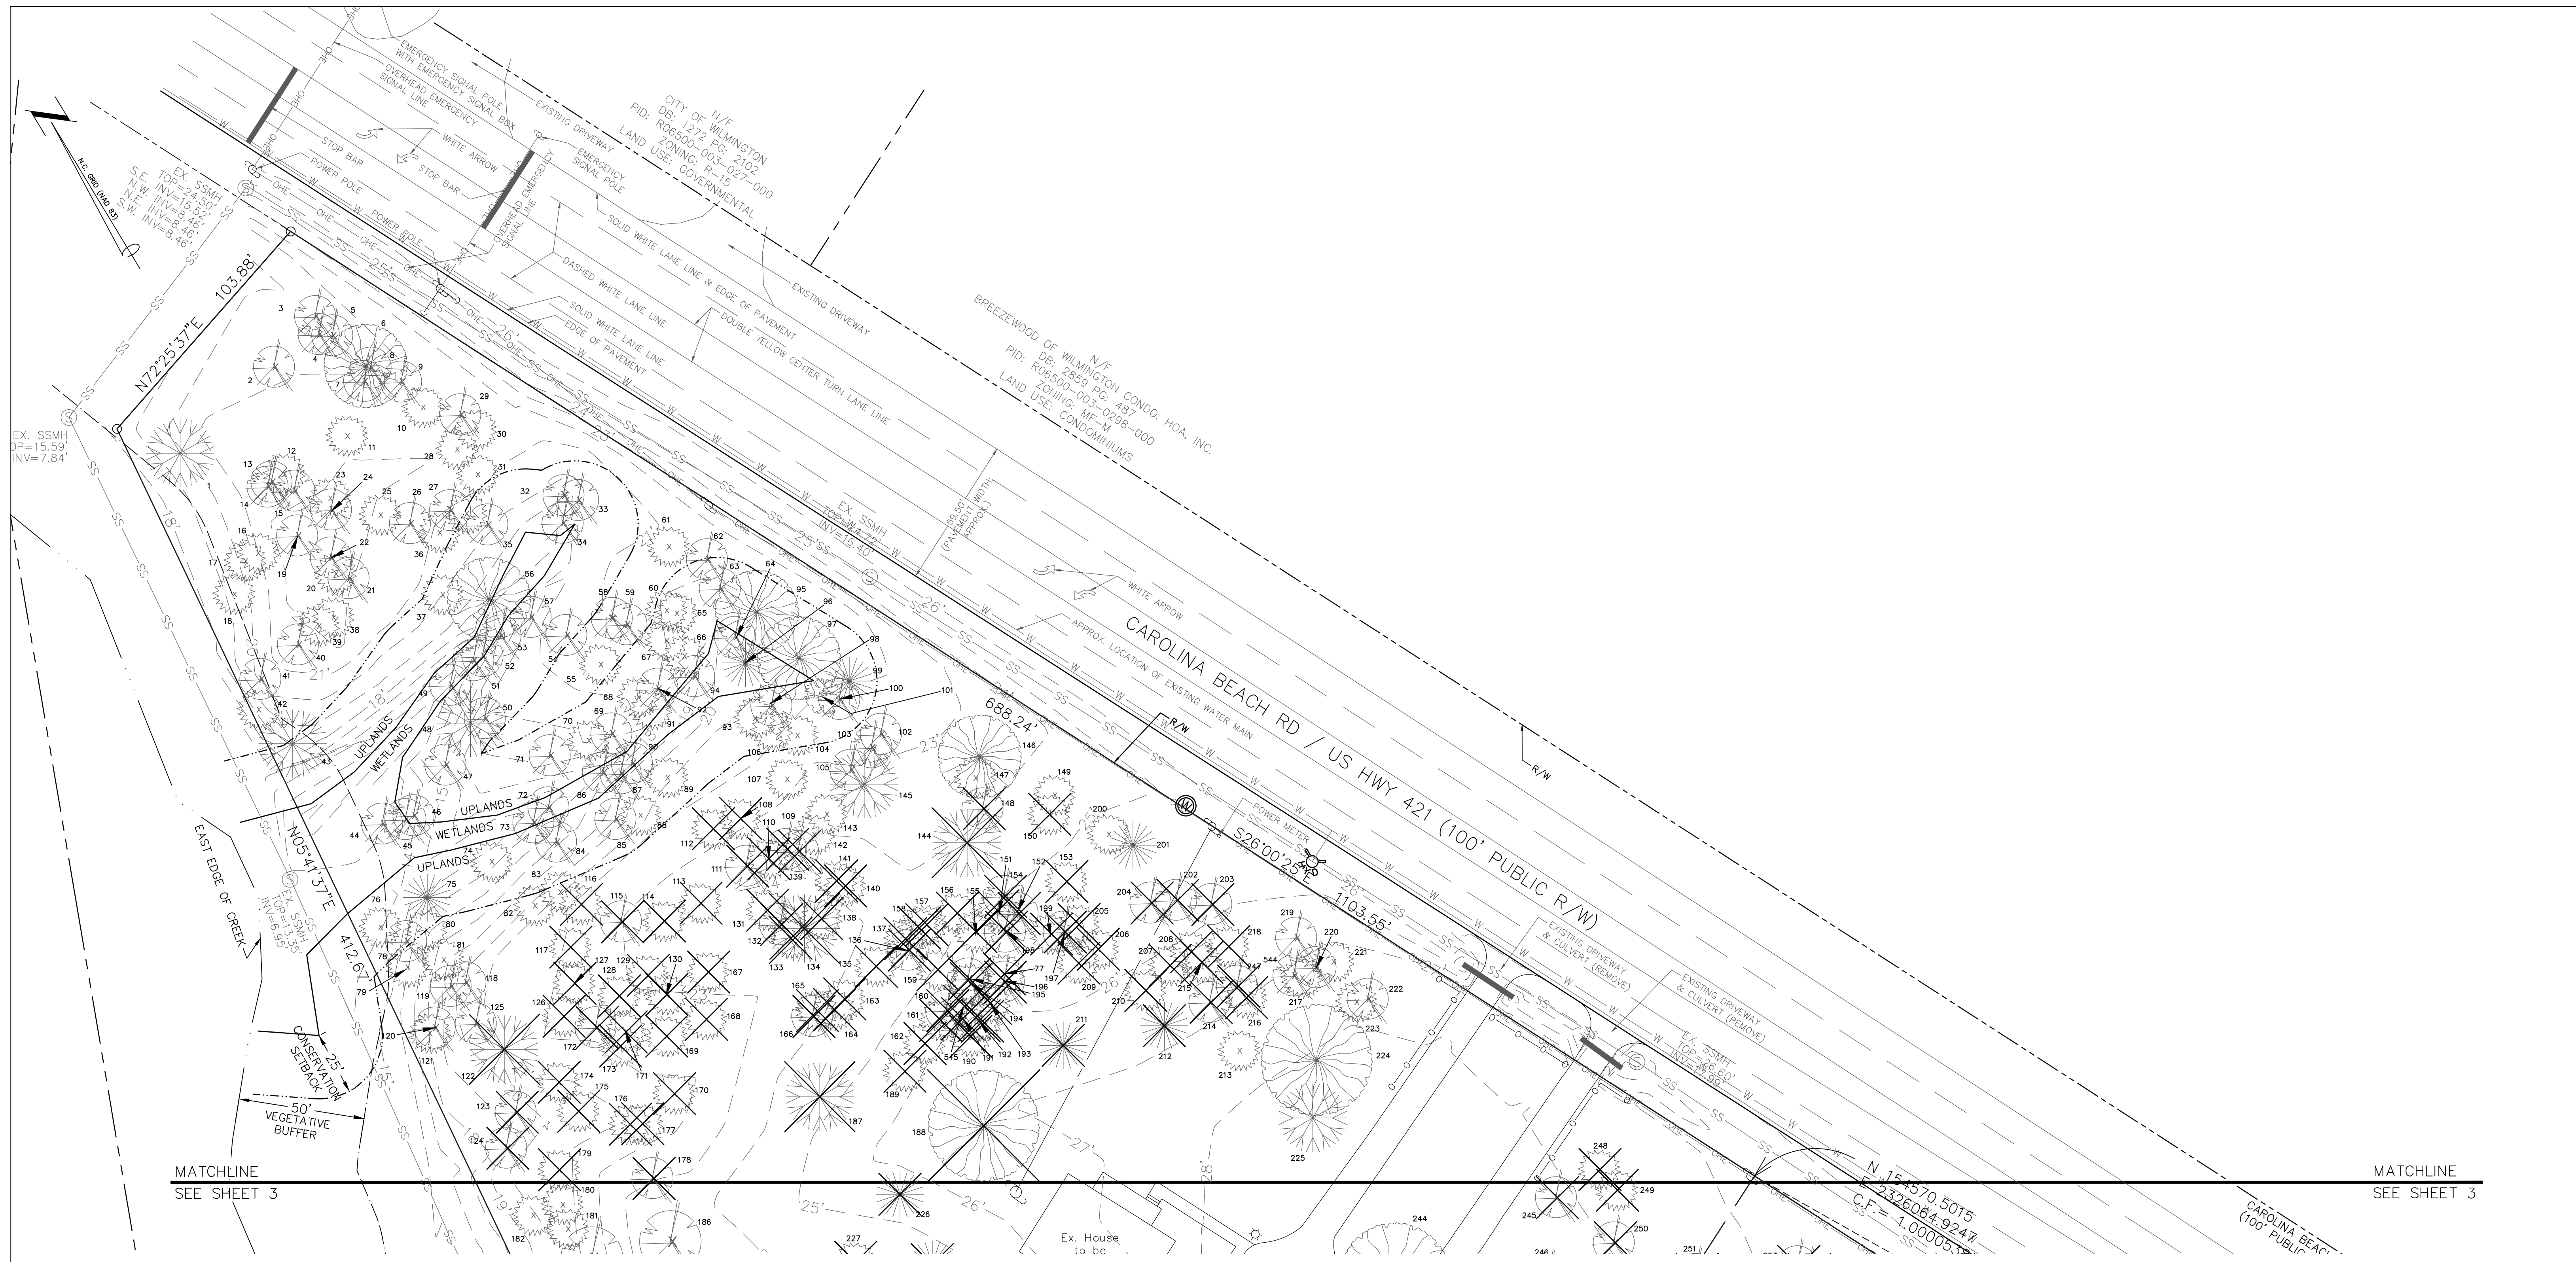

MATCHLINE
SEE SHEET 3

MATCHLINE
SEE SHEET 3

Approved Construction Plan

Name _____ Date _____

Planning _____

Traffic _____

Fire _____


CITY OF WILMINGTON
NORTH CAROLINA

Public Services • Engineering Division

APPROVED STORMWATER MANAGEMENT PLAN

Date: _____ Permit # _____

Signed: _____

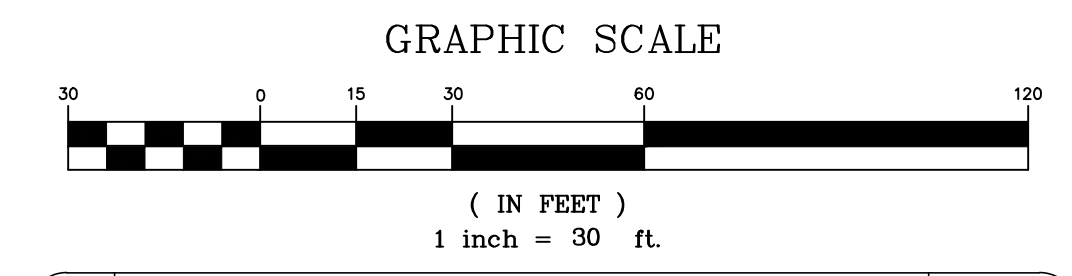

REV. NO.	DESCRIPTION	DATE
1	REVISED FOR SRM SUBMITTAL	9-2-15
2	REVISED TO PROVIDE ADJUSTED SURVEY DATA	10-12-15
3	REVISED FOR PRELIMINARY BID	10-16-15
4	REVISED PER TRC COMMENTS	11-12-15
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6	REVISED PER CITY TO SAVE ADDITIONAL TREES	11-24-15

EXISTING CONDITIONS & DEMOLITION PLAN
4010 CAROLINA BEACH ROAD
ECHO FARM APARTMENTS
WILMINGTON TOWNSHIP NEW HANOVER COUNTY NORTH CAROLINA

FINAL DRAWING FOR REVIEW PURPOSES ONLY

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1134 SHIPYARD BOULEVARD
WILMINGTON, NORTH CAROLINA 28412
Phone 910-392-6343
Fax 910-392-5203 License No. C-2320

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WILMINGTON, NORTH CAROLINA 28403
PHONE: 910-251-5030

DATE: 7-22-15
SCALE: 1"=30'
DRAWN: JCB
CHECKED: JEM
PROJECT NO: 260

SHEET NO: 4
OF: 22

PRELIMINARY PLAT
NOT FOR RECORDATION,
CONVEYANCES, OR SALES

MATCHLINE
SEE SHEET 6

MATCHLINE
SEE SHEET 6

N/F
CITY OF WILMINGTON
DB: 1272 PG: 650
PID: R06500-004-001-003
ZONING: R-15
LAND USE: UNUSED

BENCHMARK
ELEV. = 17.55'

EAST EDGE OF CREEK

50' VEGETATIVE BUFFER

WETLANDS UPLANDS

N/F
CITY OF WILMINGTON
DB: 1272 PG: 650
PID: R06500-004-001-004
ZONING: R-15
LAND USE: UNUSED

25' CONSERVATION SETBACK

N39°52'37"E 218.00'

N47°05'37"E 261.29'

N47°05'37"E 261.29'

N47°05'37"E 261.29'

N47°05'37"E 261.29'

N47°05'37"E 261.29'

N47°05'37"E 261.29'

BUILDING #8

POOL

CLUBHOUSE

WET POND

INFILTRATION BASIN #1

BUILDING #2

MAINTENANCE BUILDING

N/F
ECHO FARMS, LLC
DB: 2307 PG: 467
PID: R07006-002-001-000
ZONING: MF-M
LAND USE: RECREATIONAL

N/F
JOANN McKENNA TRUST
DB: 5128 PG: 2275
PID: R07007-004-001-000
ZONING: O&I-1
LAND USE: UNUSED

GRAPHIC SCALE



(IN FEET)
1 inch = 30 ft.

Approved Construction Plan
Name _____ Date _____
Planning _____
Traffic _____
Fire _____

CITY OF WILMINGTON
NORTH CAROLINA
Public Services • Engineering Division
APPROVED STORMWATER MANAGEMENT PLAN
Date: _____ Permit # _____
Signed: _____

SITE INVENTORY
4010 CAROLINA BEACH ROAD
ECHO FARM APARTMENTS
WILMINGTON TOWNSHIP NEW HANOVER COUNTY NORTH CAROLINA

FINAL
DRAWING
FOR REVIEW
PURPOSES
ONLY

MALPASS ENGINEERING & SURVEYING, P.C.
1134 SHIPYARD BOULEVARD
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Phone 910-392-6243
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WILMINGTON, NORTH CAROLINA 28403
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PROJECT NO: 260


SHEET NO: 5
OF: 22

REV NO.	DESCRIPTION	DATE
1	REVISED FOR SRB SUBMITTAL.	8-2-15
2	REVISED TO SHOW PRIVATE STREET.	10-12-15
3	REVISED FOR PRELIMINARY BID.	10-16-15
4	REVISED PER THE COMMENTS.	11-17-15
5	REVISED TO SHOW EXISTING OFF-SITE TREES ALONG/NEAR WET POND #1 OUTFALL PIPE.	11-20-15
6	REVISED PER CITY TO SAVE ADDITIONAL TREES.	11-24-15
7	REVISED TO PROVIDE SIDEWALK ALONG CAROLINA BEACH RD.	12-14-15
8	REVISED PER CITY.	2-9-16

ECHO FARMS BLVD
(60' PUBLIC R/W)

PRELIMINARY PLAT
NOT FOR RECORDATION,
CONVEYANCES, OR SALES

N/F
ECHO FARMS, LLC
DB: 2307 PG: 467
PID: R07006-002-001-000
ZONING: MF-M
LAND USE: RECREATIONAL

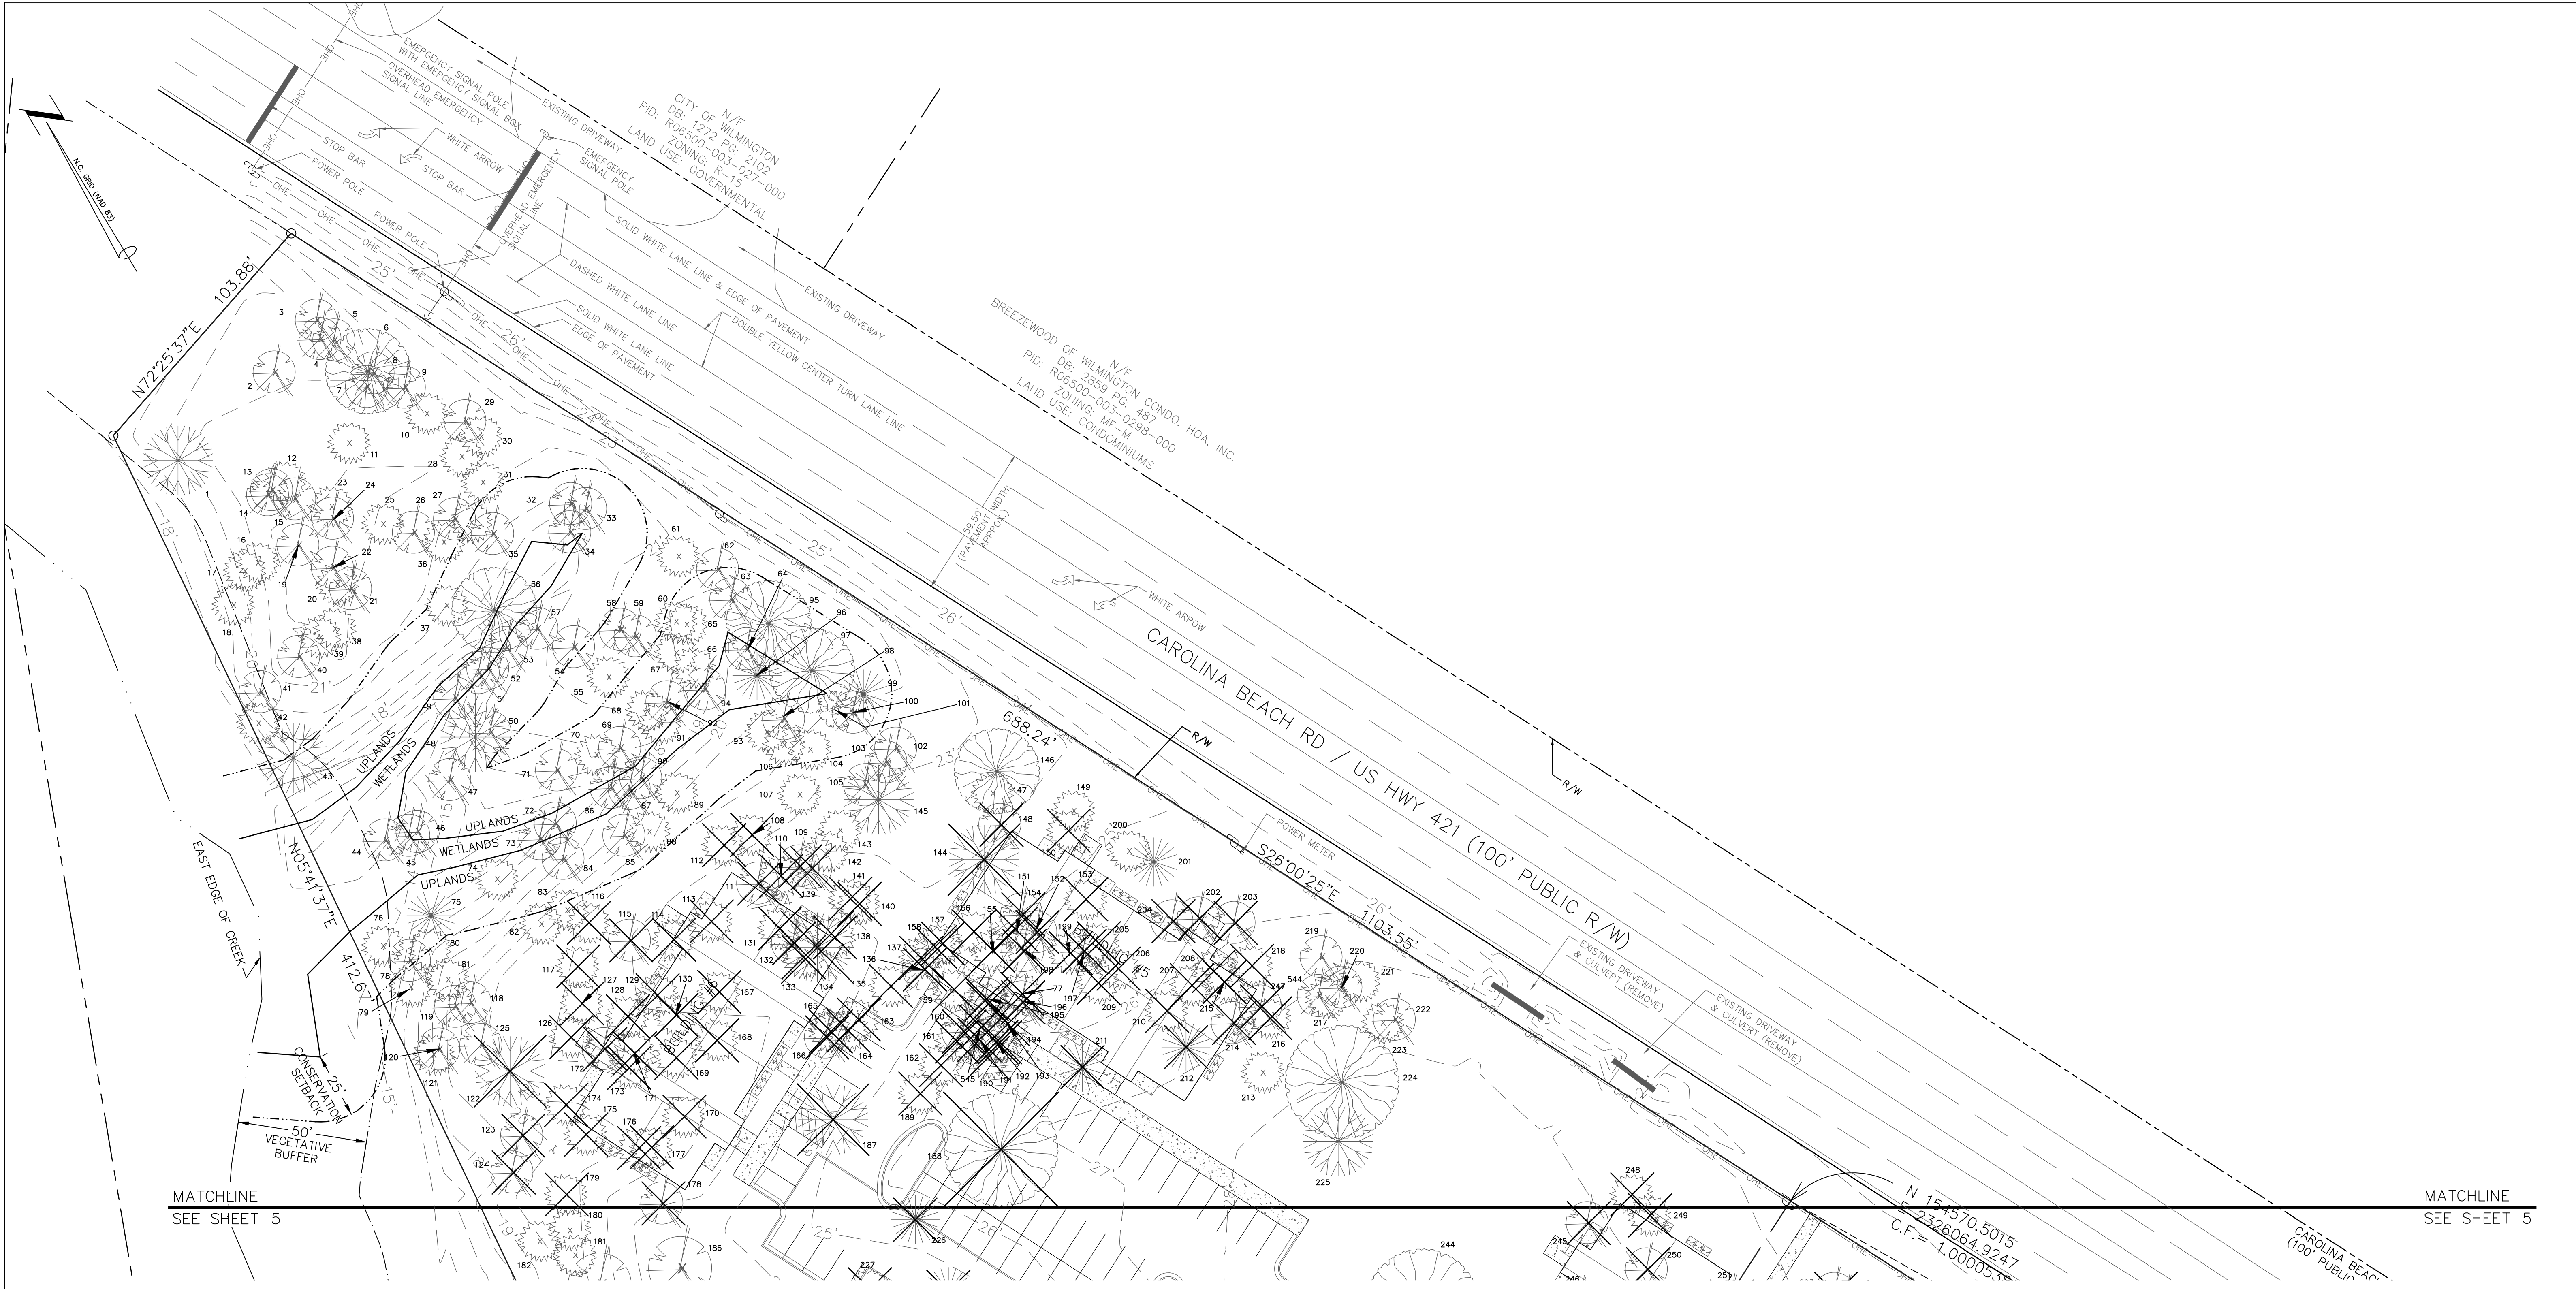

MATCHLINE
SEE SHEET 5

MATCHLINE
SEE SHEET 5

Approved Construction Plan

Name _____ Date _____

Planning _____

Traffic _____

Fire _____


WILMINGTON
NORTH CAROLINA

Public Services • Engineering Division

APPROVED STORMWATER MANAGEMENT PLAN

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SITE INVENTORY
4010 CAROLINA BEACH ROAD
ECHO FARM APARTMENTS
WILMINGTON TOWNSHIP NEW HANOVER COUNTY NORTH CAROLINA

FINAL DRAWING FOR REVIEW PURPOSES ONLY

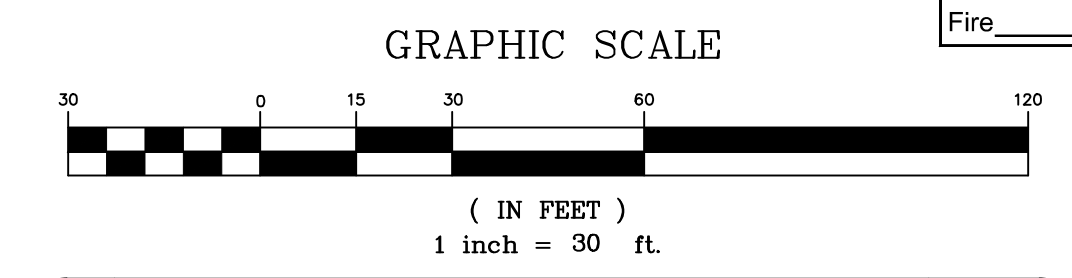MALPASS ENGINEERING & SURVEYING, P.C.
1134 SHIPYARD BOULEVARD
WILMINGTON, NORTH CAROLINA 28412
Phone 910-392-5243
Fax 910-392-5203 License No. C-2320

Developer: ECHO FARM APARTMENTS, LLC
10 S. CARDINAL DRIVE
WILMINGTON, NORTH CAROLINA 28403
PHONE: 910-251-5030

DATE: 7-22-15
SCALE: 1"=30'
DRAWN: JCB
CHECKED: JEM
PROJECT NO: 260

SHEET NO: 6
OF: 22

PRELIMINARY PLAT
NOT FOR RECORDATION,
CONVEYANCES, OR SALES

MATCHLINE
SEE SHEET 8

17,888 SF

MATCHLINE
SEE SHEET 8

N/F
CITY OF WILMINGTON
DB: 1272 PG: 650
PID: R06500-004-001-003
ZONING: R-15
LAND USE: UNUSED

BENCHMARK
ELEV. = 17.55'

N/F
CITY OF WILMINGTON
DB: 1272 PG: 650
PID: R06500-004-001-004
ZONING: R-15
LAND USE: UNUSED

ACTIVE RECREATION AREA
6,072 SF

PASSIVE RECREATION AREA
62,837 SF

OPEN SPACE
18,682 SF


N/F
JOANN MCKENNA TRUST
DB: 5128 PG: 2275
PID: R07007-004-001-000
ZONING: O&I-1
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N/F
ECHO FARMS, LLC
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ZONING: MF-M
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N/F
ECHO FARMS, LLC
DB: 2307 PG: 467
PID: R07006-002-001-000
ZONING: MF-M
LAND USE: RECREATIONAL

ECHO FARMS BLVD
(60' PUBLIC R/W)

GRAPHIC SCALE



(IN FEET)
1 inch = 30 ft.

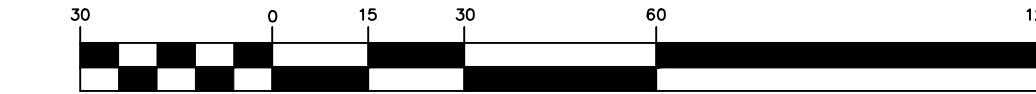Approved Construction Plan
Name _____ Date _____
Planning _____
Traffic _____
Fire _____

WILMINGTON
NORTH CAROLINA
Public Services • Engineering Division
APPROVED STORMWATER MANAGEMENT PLAN
Date: _____ Permit # _____
Signed: _____

SITE PLAN
4010 CAROLINA BEACH ROAD
ECHO FARM APARTMENTS
WILMINGTON TOWNSHIP NEW HANOVER COUNTY NORTH CAROLINA

FINAL DRAWING FOR REVIEW PURPOSES ONLY

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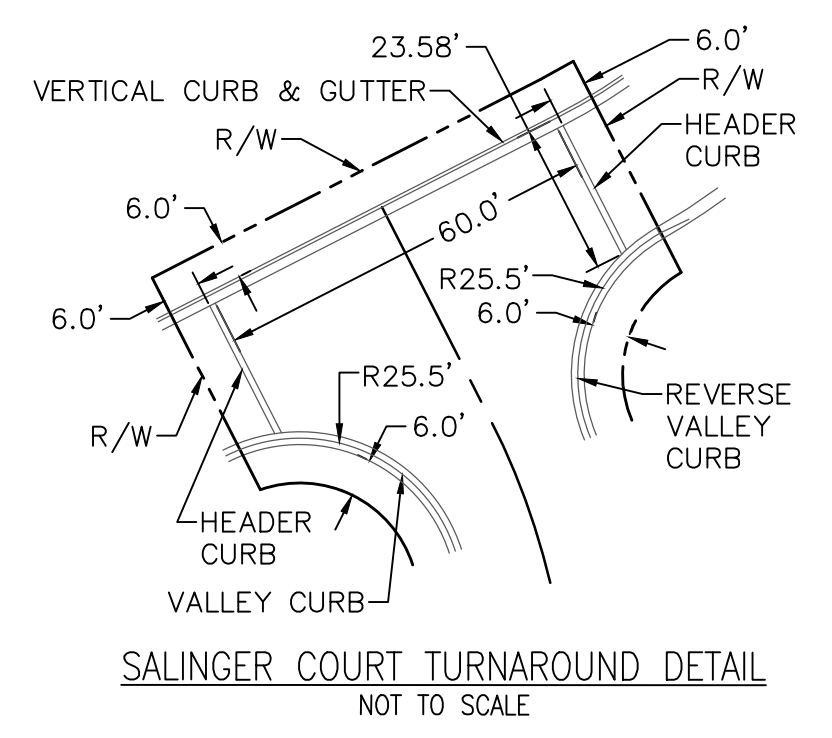
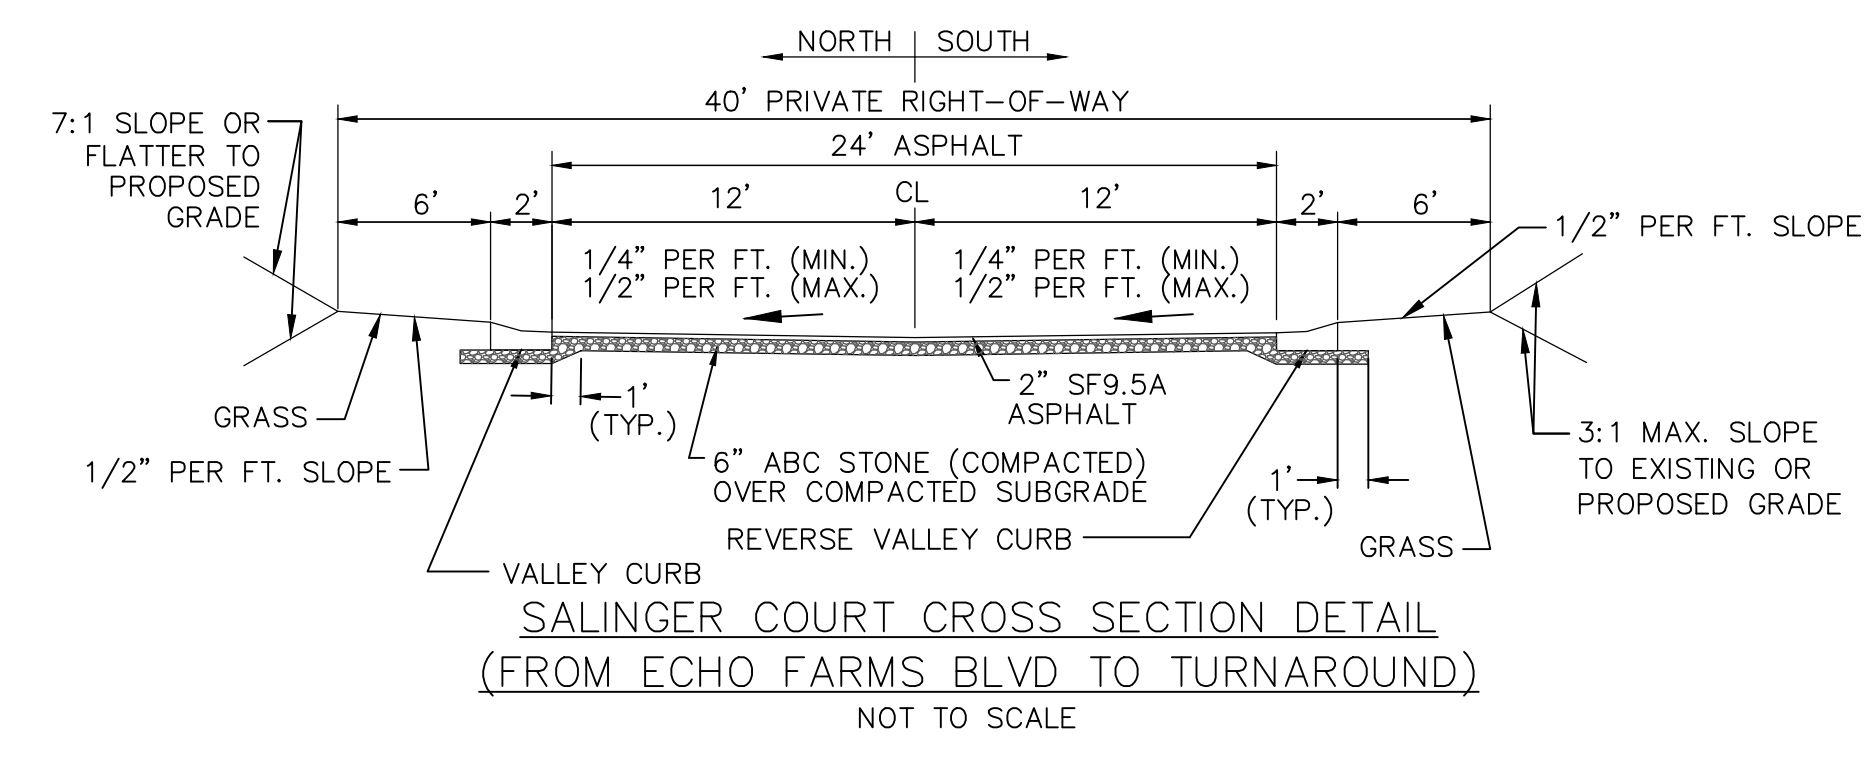
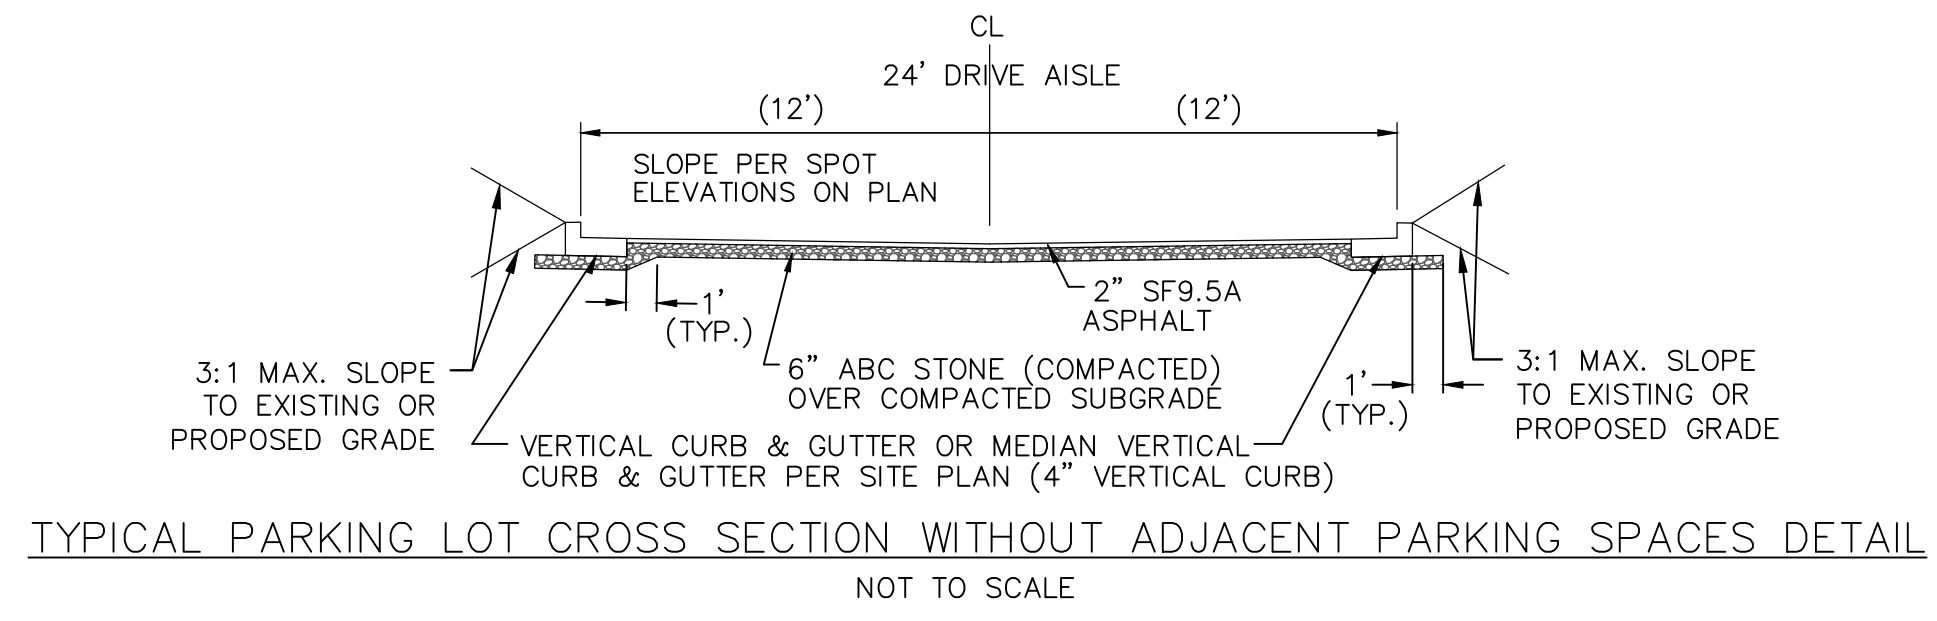
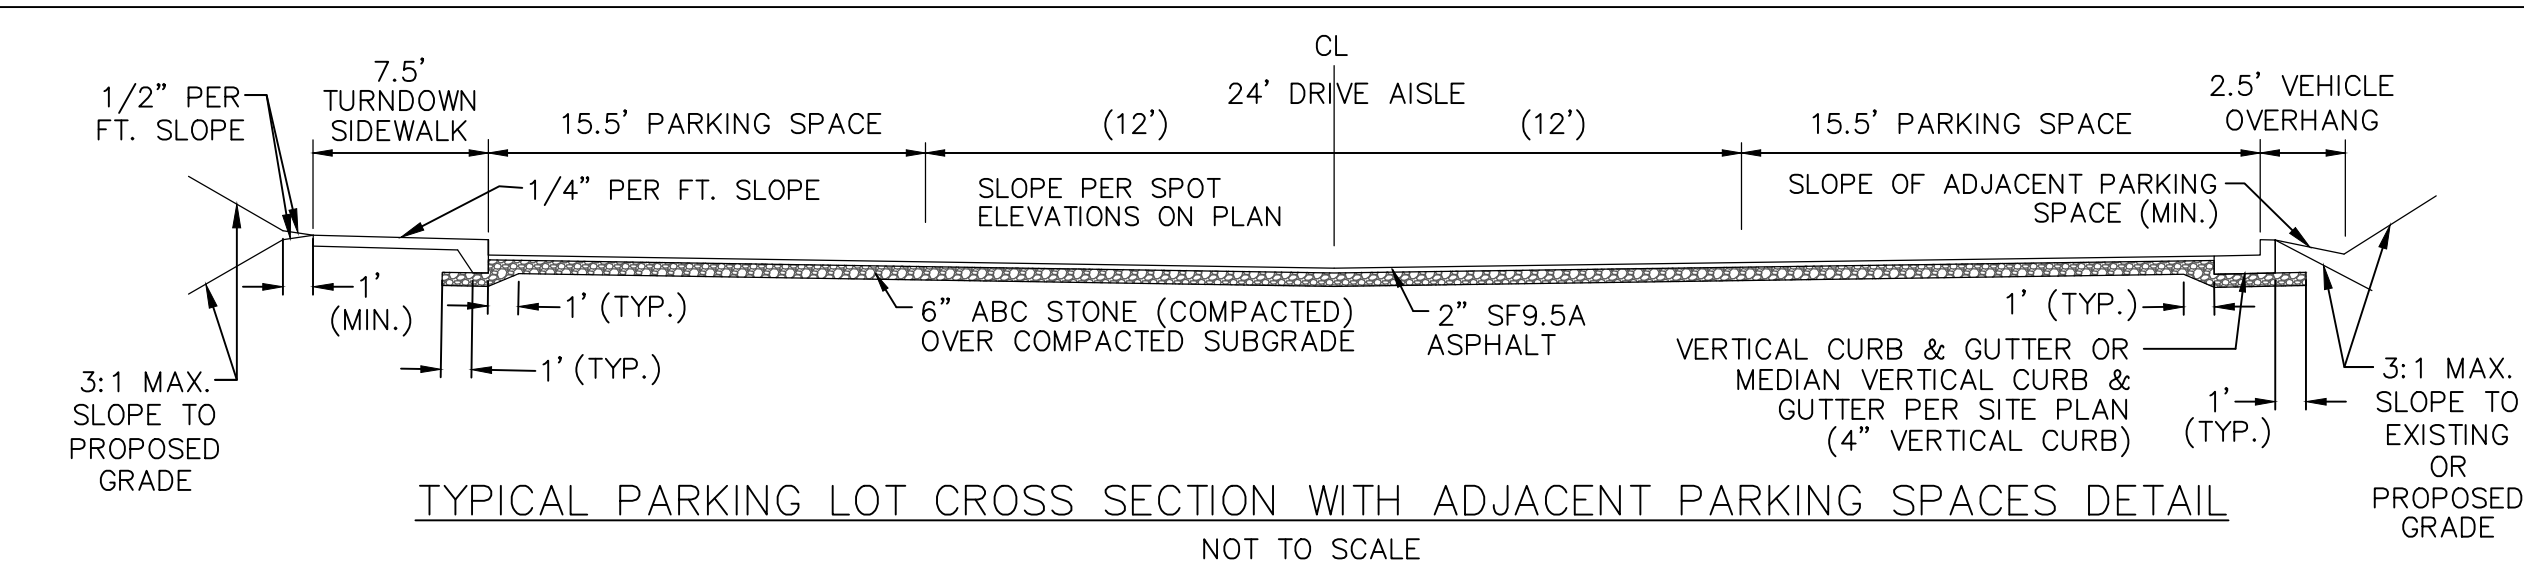
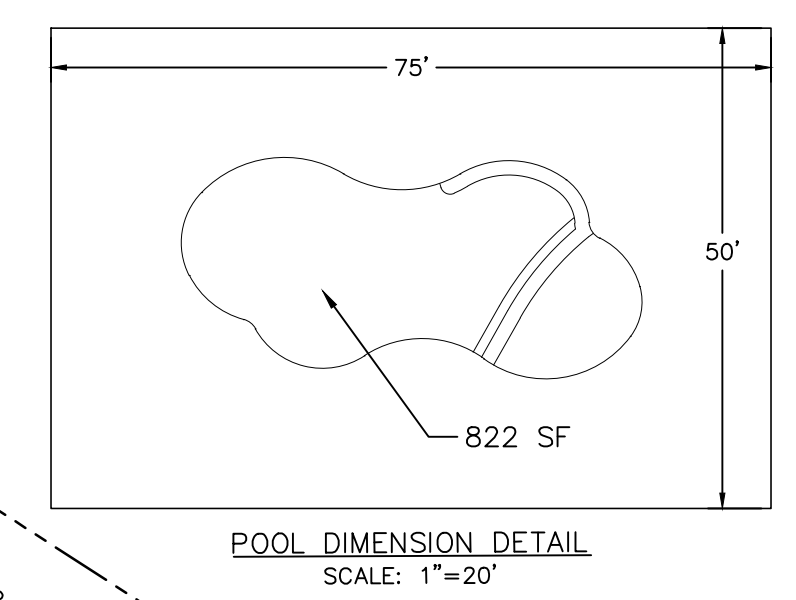
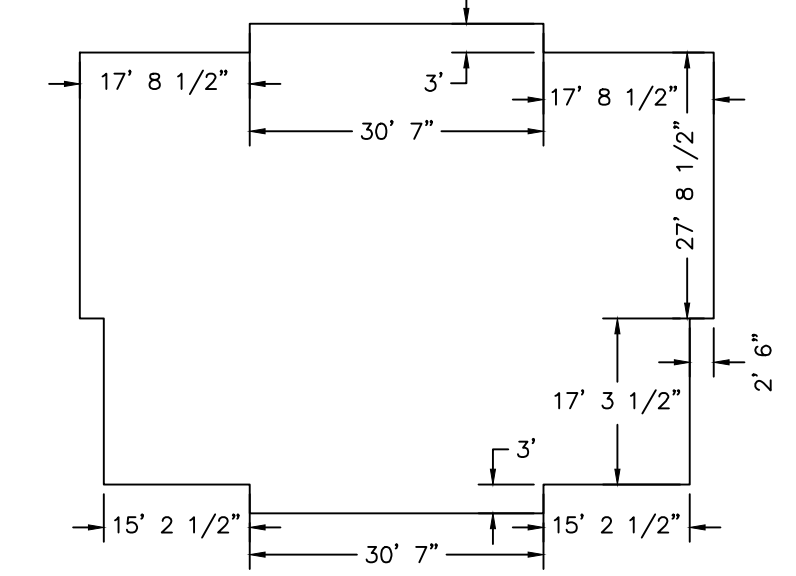
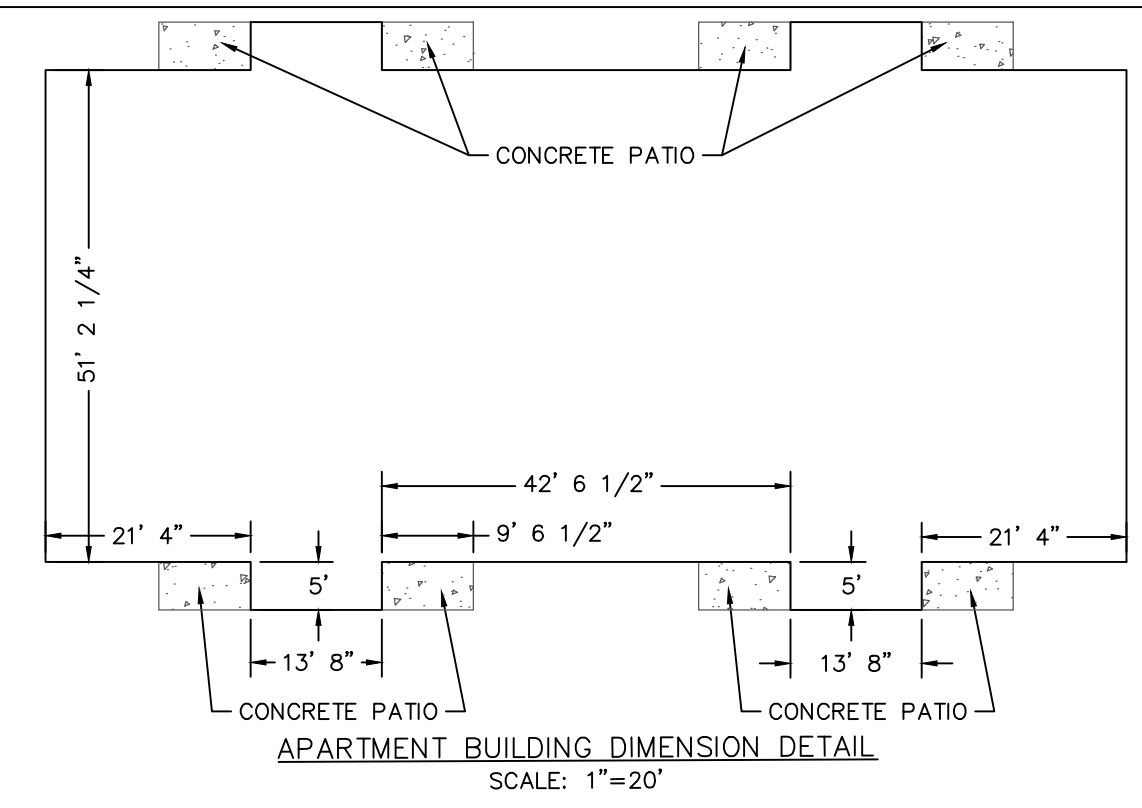
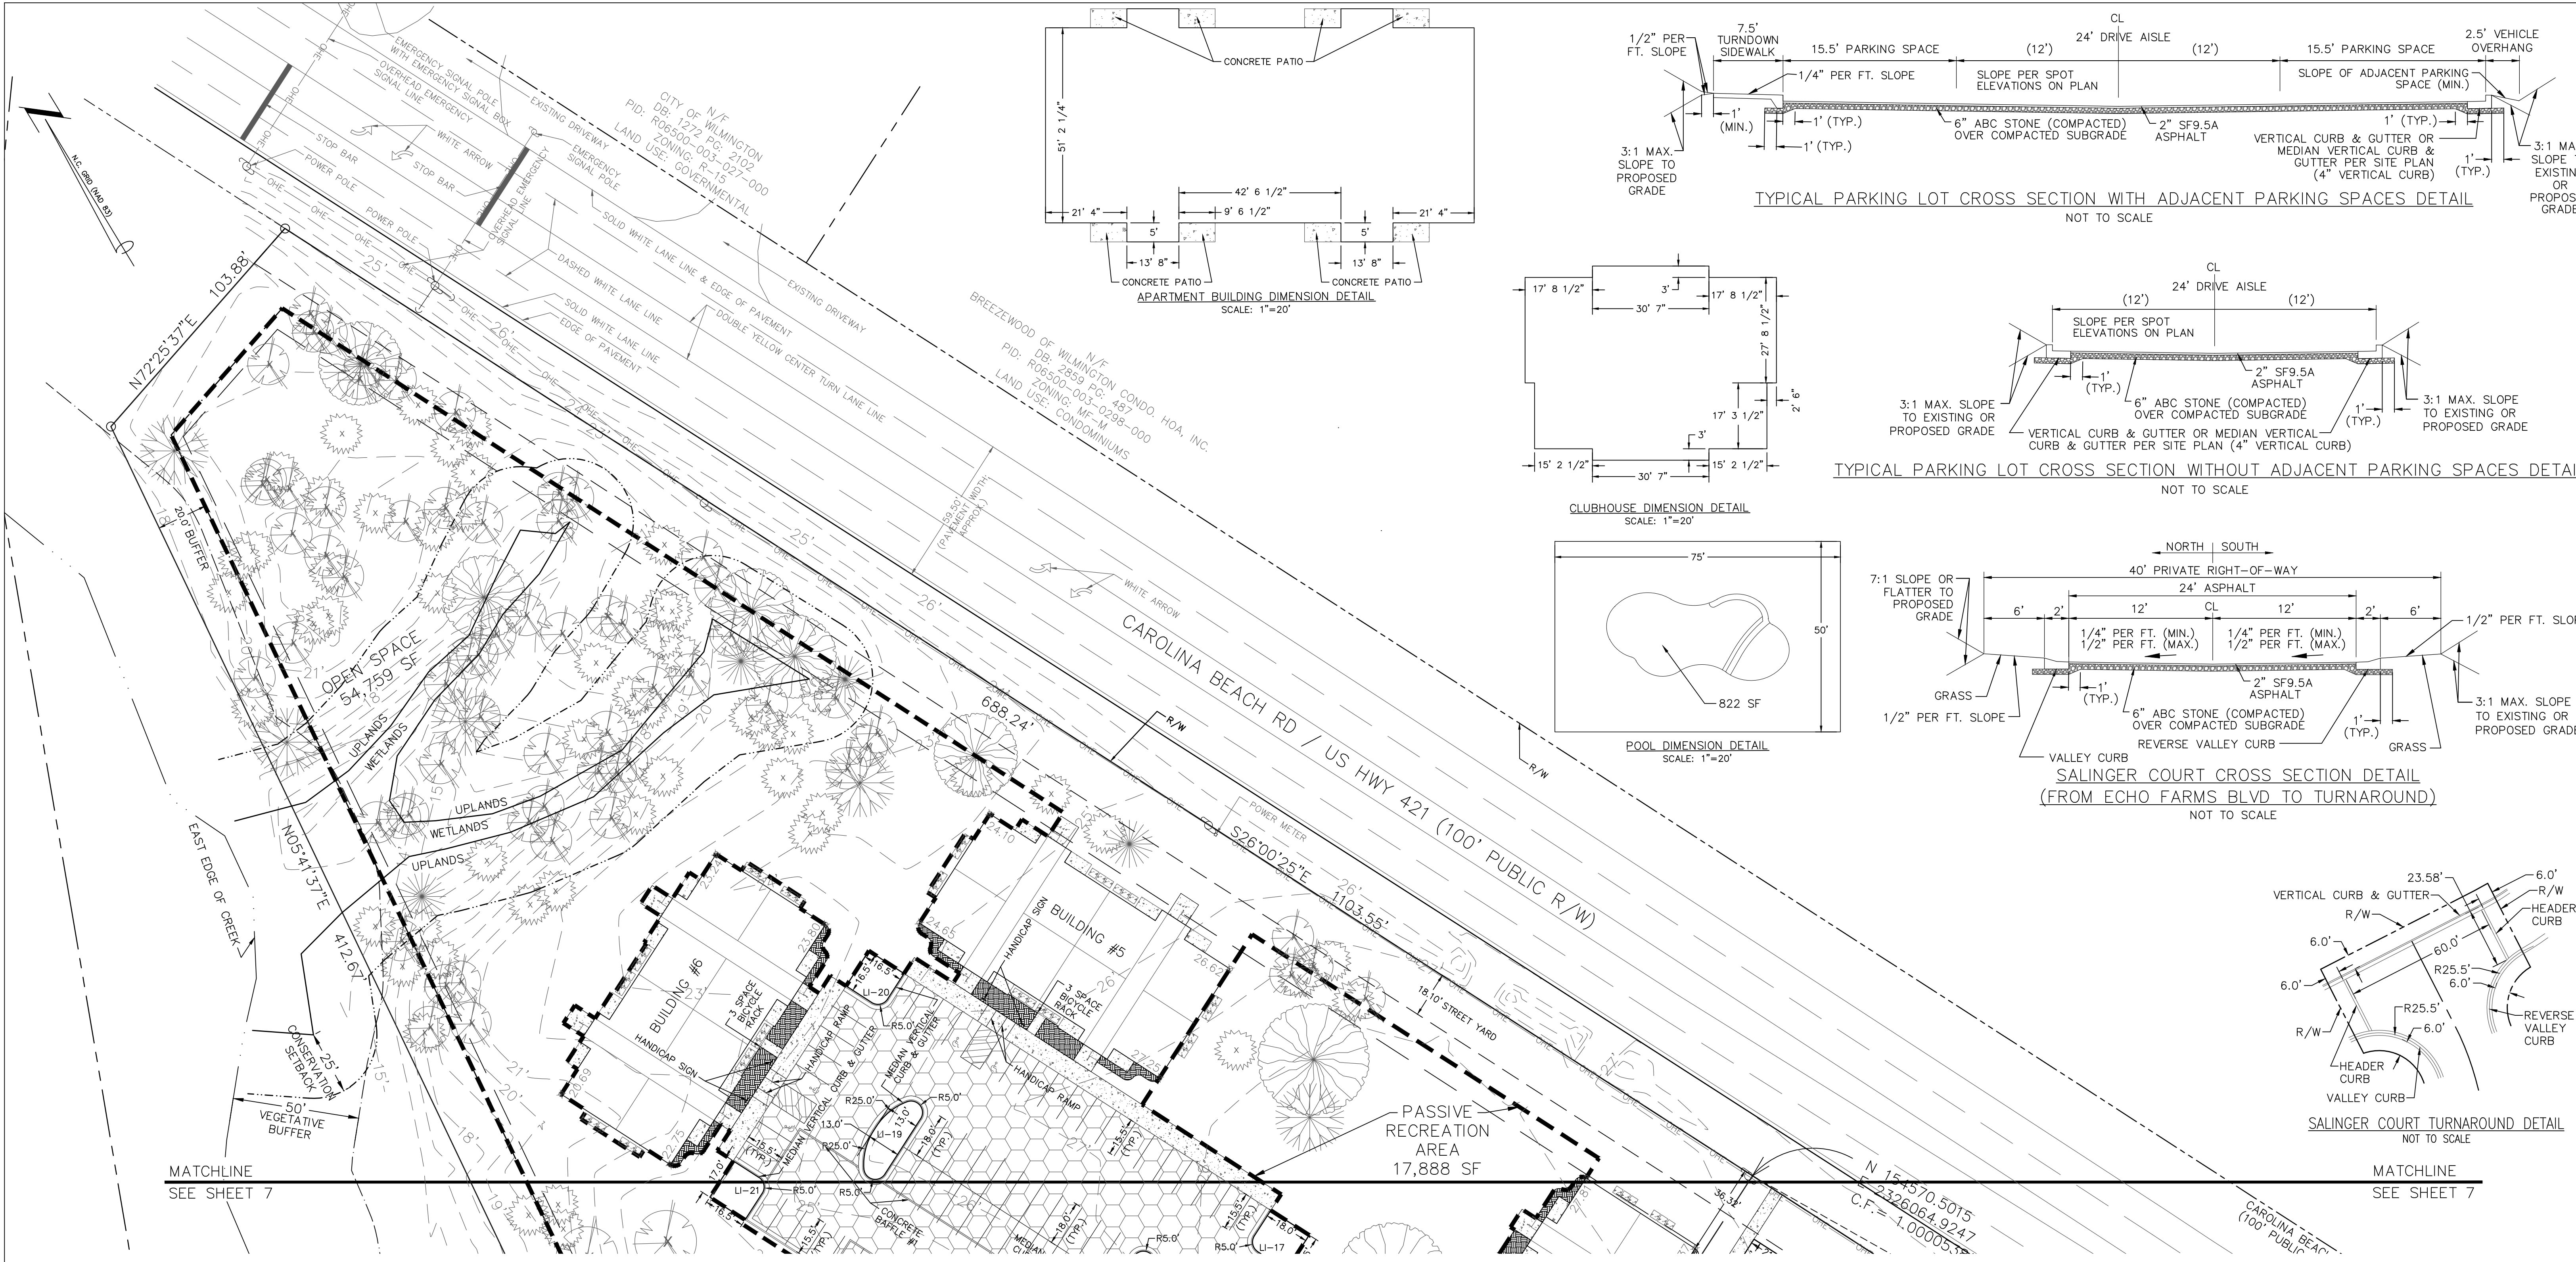
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10 S. CARDINAL DRIVE
WILMINGTON, NORTH CAROLINA 28403
PHONE: 910-251-5030

DATE: 7-22-15
SCALE: 1"=30'
DRAWN: JCB
CHECKED: JEM
PROJECT NO: 260

SHEET NO: 7
OF: 22

REV NO.	DESCRIPTION	DATE
1	REVISED FOR SBD SUBMITTAL	9-2-15
2	REVISED TO SHOW PRIVATE STREET	10-12-15
3	REVISED FOR PRELIMINARY BID	10-16-15
4	REVISED PER THE COMMENTS	11-12-15
5	REVISED PER CITY TO SAME ADDITIONAL TREES	11-24-15
6	REVISED TO PROVIDE SIDEWALK ALONG CAROLINA BEACH RD & CURB CUT NORTH OF BUILDING #8	12-14-15
7	REVISED PER CITY	2-9-16

PRELIMINARY PLAT
NOT FOR RECORDATION,
CONVEYANCES, OR SALES



LANDSCAPE ISLAND	TOTAL AREA (SF)	IMPERVIOUS AREA (SF)	PERCENT IMPERVIOUS
LI-1	224.80	0	0
LI-2	288.80	0	0
LI-3	225.12	0	0
LI-4	220.13	0	0
LI-5	248.52	0	0
LI-6	281.12	0	0
LI-7	282.65	0	0
LI-8	339.15	0	0
LI-9	287.15	0	0
LI-10	378.84	0	0
LI-11	378.84	0	0
LI-12	355.84	0	0
LI-13	491.09	0	0
LI-14	609.04	0	0
LI-15	229.69	0	0
LI-16	283.78	0	0
LI-17	292.65	0	0
LI-18	378.84	0	0
LI-19	378.84	0	0
LI-20	267.80	0	0
LI-21	276.15	0	0
LI-22	397.14	0	0
LI-23	367.99	0	0
LI-24	378.84	0	0
LI-25	378.84	0	0
LI-26	276.15	0	0
LI-27	276.15	0	0
LI-28	1,171.14	147.53	12.60
LI-29	278.99	0	0
LI-30	224.31	0	0
LI-31	223.15	0	0
LI-32	217.52	0	0
LI-33	221.34	0	0
LI-34	223.06	0	0
LI-35	288.80	0	0
LI-36	216.67	0	0

TREES PER DISTURBED ACRE
 9.63 AGRES * 15 = 144.45, 144 TREES REQUIRED
 *SEE LANDSCAPING PLAN FOR PROVIDED TREES

STREET YARD-CAROLINA BEACH ROAD (PRIMARY FRONTAGE)
 STREET FRONTAGE = 1,103.55 FT
 REQUIRED STREET YARD = 18 * 1,103.55 = 19,863.90 SF
 PROVIDED STREET YARD = 19,937.57 SF
 IMPERVIOUS AREA = 0 SF
 PERCENT IMPERVIOUS = 0 / 19,937.57 * 100% = 0%
 REQUIRED PLANTING = 19,937.57 / 600 = 33.23, 33 CANOPY TREES (OR 3 UNDERSTORY TREES PER 1 CANOPY TREE)
 33.23 * 6 = 199.38, 199 SHRUBS
 *SEE LANDSCAPING PLAN FOR PROVIDED TREES & SHRUBS

STREET YARD-ECHO FARMS BLVD (SECONDARY FRONTAGE)
 STREET FRONTAGE = 469.83 - 37.53 = 432.30 FT
 REQUIRED STREET YARD = 18 * 432.30 / 2 = 3,890.70 SF
 PROVIDED STREET YARD = 3,461.82 + 578.81 = 4,040.63 SF
 IMPERVIOUS AREA = 233.20 SF
 PERCENT IMPERVIOUS = 233.20 / 4,040.63 * 100% = 5.78%
 REQUIRED PLANTING = 4,040.63 / 600 = 6.74, 7 CANOPY TREES (OR 3 UNDERSTORY TREES PER 1 CANOPY TREE)
 6.74 * 6 = 40.44, 40 SHRUBS
 *SEE LANDSCAPING PLAN FOR PROVIDED TREES & SHRUBS


INTERIOR SHADING
 PARKING FACILITY AREA [PARKING LOT AREA TO BACK OF CURB (OR BACK OF SIDEWALK ADJACENT TO PARKING SPACES) MINUS LANDSCAPE ISLANDS PLUS PRIVATE STREET (INCLUDING PORTION WITHIN ECHO FARMS BLVD R/W)]
 124,085 SF
 REQUIRED INTERIOR SHADING (IS) = 0.2 * 124,085 = 24,817 SF
 *SEE LANDSCAPING PLAN FOR PROVIDED INTERIOR SHADING & TREES

FOUNDATION PLANTING-FRONT OR REAR OF BUILDINGS #1-8 (PER FRONT OR REAR OF BUILDING ADJACENT TO PARKING/DRIVE AISLE)
 REQUIRED FOUNDATION PLANTING = [(30.73' x 112.54') + (0.5' x 10.62' x 31.86')] * 0.12 = 455.61 SF
 PROVIDED FOUNDATION PLANTING (BUILDINGS #1 & 3-8) = 508.48 SF
 PROVIDED FOUNDATION PLANTING (BUILDING #2) = 560.10 SF
 *SEE LANDSCAPING PLAN FOR PROVIDED PLANTINGS

FOUNDATION PLANTING-SIDE OF BUILDINGS #1, 2, 3, 4, 7, & 8 (PER SIDE OF BUILDING ADJACENT TO PARKING/DRIVE AISLE)
 REQUIRED FOUNDATION PLANTING = [(31.44' x 51.19') + (0.5' x 12.63' x 50.53')] * 0.12 = 231.43 SF
 PROVIDED FOUNDATION PLANTING (BUILDINGS #1 & 2) = 262.12 SF
 PROVIDED FOUNDATION PLANTING (BUILDINGS #3 & 4) = 236.31 SF
 PROVIDED FOUNDATION PLANTING (BUILDING #7) = 267.45 SF
 PROVIDED FOUNDATION PLANTING (BUILDING #8) = 280.41 SF
 *SEE LANDSCAPING PLAN FOR PROVIDED PLANTINGS

FOUNDATION PLANTING-FRONT OF CLUBHOUSE
 REQUIRED FOUNDATION PLANTING = [(8.98' x 14.09') + (11.31' x 31.43') + (8.98' x 19.98') + (13.81' x 4.61' x 0.5) + 87.47 SF] * 0.12 = 93.69 SF
 PROVIDED FOUNDATION PLANTING = 169.84 SF
 *SEE LANDSCAPING PLAN FOR PROVIDED PLANTINGS

FOUNDATION PLANTING-FRONT OF MAINTENANCE BUILDING
 REQUIRED FOUNDATION PLANTING = [(10.00' x 20.00') + (0.5' x 6.67' x 20.00')] * 0.12 = 32 SF
 PROVIDED FOUNDATION PLANTING = 33.42 SF
 *SEE LANDSCAPING PLAN FOR PROVIDED PLANTINGS

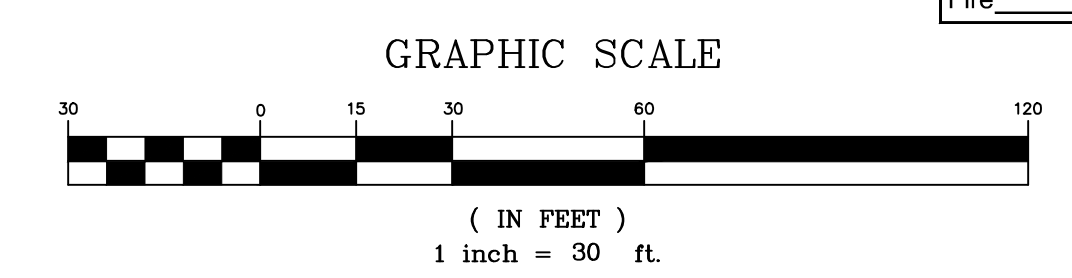

REV NO.	DESCRIPTION	DATE
1	REVISED FOR SRB SUBMITTAL	9-2-15
2	REVISED TO PROVIDE ADJUSTED SURVEY DATA	10-12-15
3	REVISED FOR PRELIMINARY BID	10-16-15
4	REVISED PER THE COMMENTS	11-12-15
5	REVISED PER CITY TO SAVE ADDITIONAL TREES	11-24-15
6	REVISED TO PROVIDE SIDEWALK ALONG CAROLINA BEACH RD, STREET YARD CALC, & TREE CALC.	12-14-15
7	REVISED PER CITY	2-9-16

Approved Construction Plan

Name _____ Date _____

Planning _____

Traffic _____

Fire _____

CITY OF WILMINGTON
 NORTH CAROLINA
 Public Services • Engineering Division
APPROVED STORMWATER MANAGEMENT PLAN
 Date: _____ Permit # _____
 Signed: _____

ECHO FARM APARTMENTS
 WILMINGTON TOWNSHIP NEW HANOVER COUNTY NORTH CAROLINA

MALPASS ENGINEERING & SURVEYING, P.C.
 1134 SHIPYARD BOULEVARD
 WILMINGTON, NORTH CAROLINA 28412
 Phone 910-392-6343 Fax 910-392-5203 License No. C-2320


Developer: ECHO FARM APARTMENTS, LLC
 10 S. CAROLINA DRIVE
 WILMINGTON, NORTH CAROLINA 28403
 PHONE: 910-251-5030

DATE: 7-22-15
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 DRAWN: JCB
 CHECKED: JEM
 PROJECT NO: 260
 SHEET NO: 8
 OF: 22


PRELIMINARY PLAT
 NOT FOR RECORDATION,
 CONVEYANCES, OR SALES

MATCHLINE
SEE SHEET 10

MATCHLINE
SEE SHEET 10

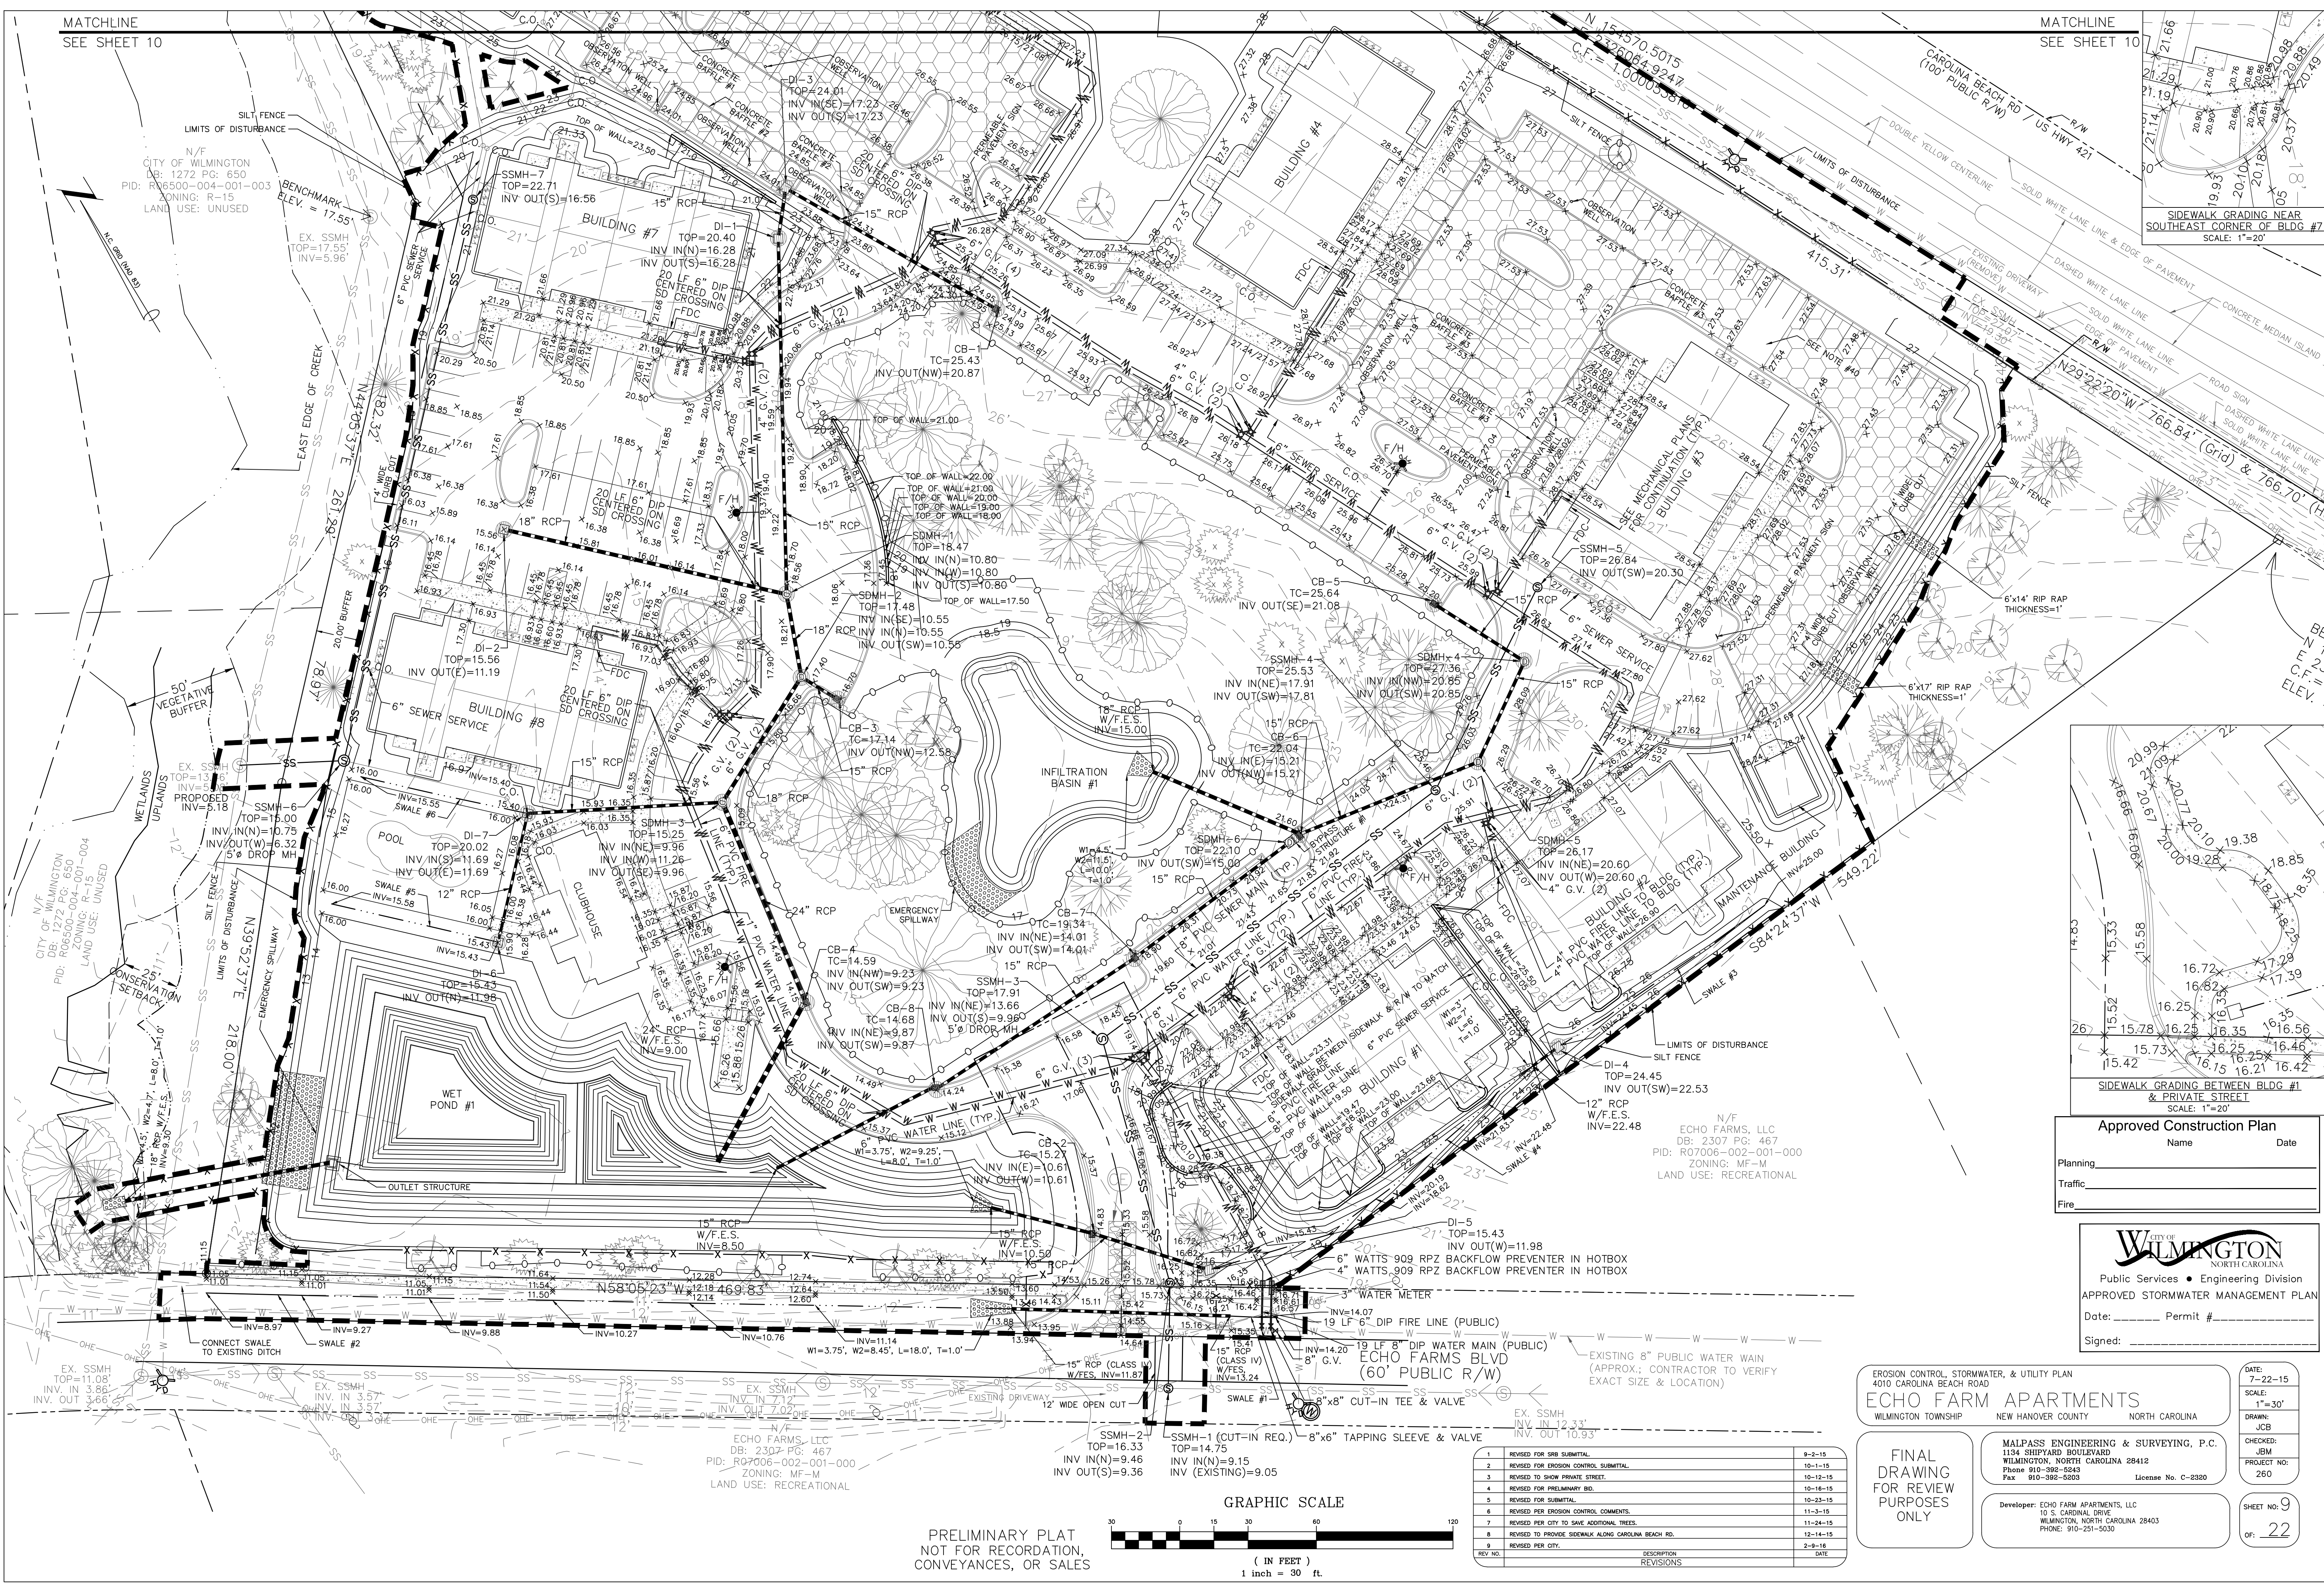

SIDEWALK GRADING NEAR
SOUTHEAST CORNER OF BLDG #7
SCALE: 1"=20'

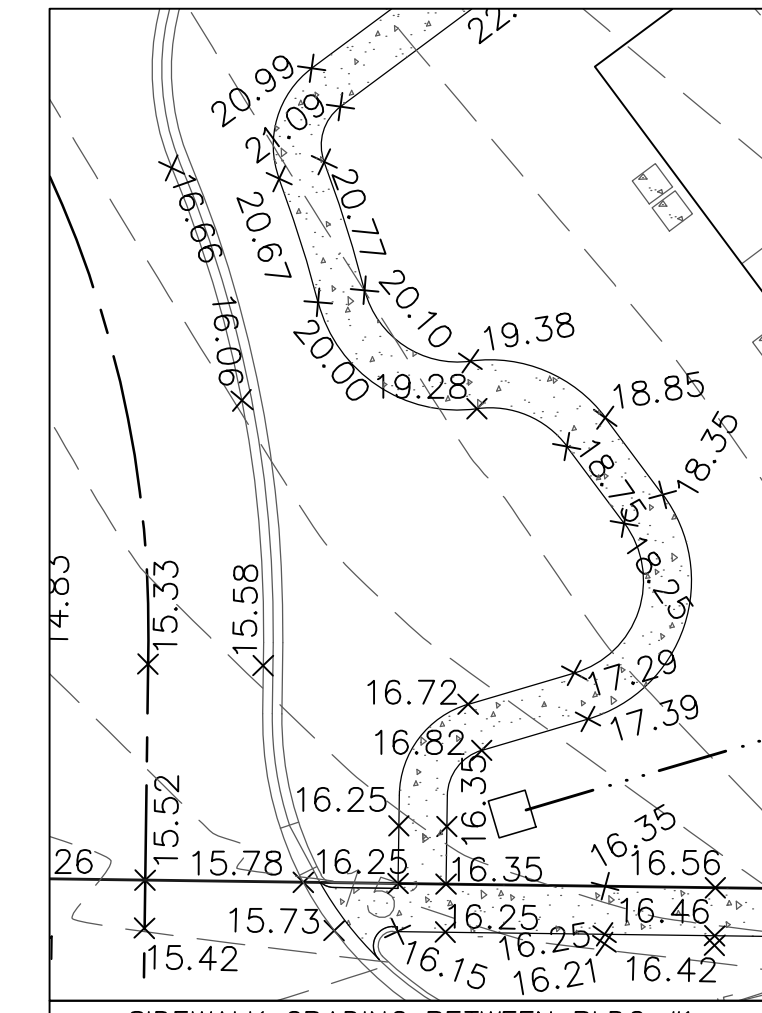

Approved Construction Plan	
Name	Date
Planning	
Traffic	
Fire	

CITY OF WILMINGTON
NORTH CAROLINA
Public Services • Engineering Division
APPROVED STORMWATER MANAGEMENT PLAN
Date: _____ Permit # _____
Signed: _____

EROSION CONTROL, STORMWATER, & UTILITY PLAN
4010 CAROLINA BEACH ROAD
ECHO FARM APARTMENTS
WILMINGTON TOWNSHIP NEW HANOVER COUNTY NORTH CAROLINA


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MALPASS ENGINEERING & SURVEYING, P.C.
1134 SHIPYARD BOULEVARD
WILMINGTON, NORTH CAROLINA 28412
Phone 910-392-5243
Fax 910-392-5203 License No. C-2320


Developer: ECHO FARM APARTMENTS, LLC
10 S. CARDINAL DRIVE
WILMINGTON, NORTH CAROLINA 28403
PHONE: 910-251-5030

DATE: 7-22-15
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DRAWN: JCB
CHECKED: JEM
PROJECT NO: 260
SHEET NO: 9
OF: 22


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1	REVISED FOR SDR SUBMITTAL	9-2-15
2	REVISED FOR EROSION CONTROL SUBMITTAL	10-1-15
3	REVISED TO SHOW PRIVATE STREET	10-12-15
4	REVISED FOR PRELIMINARY BID	10-16-15
5	REVISED FOR SUBMITTAL	10-23-15
6	REVISED PER EROSION CONTROL COMMENTS	11-3-15
7	REVISED PER CITY TO SAVE ADDITIONAL TREES	11-24-15
8	REVISED TO PROVIDE SIDEWALK ALONG CAROLINA BEACH RD.	12-14-15
9	REVISED PER CITY	2-9-16

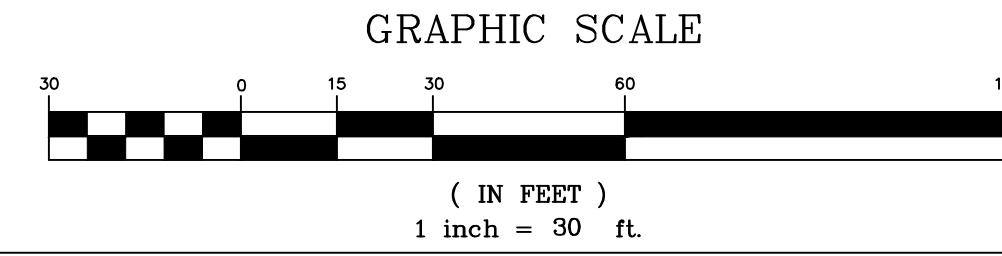

PRELIMINARY PLAT
NOT FOR RECORDATION,
CONVEYANCES, OR SALES

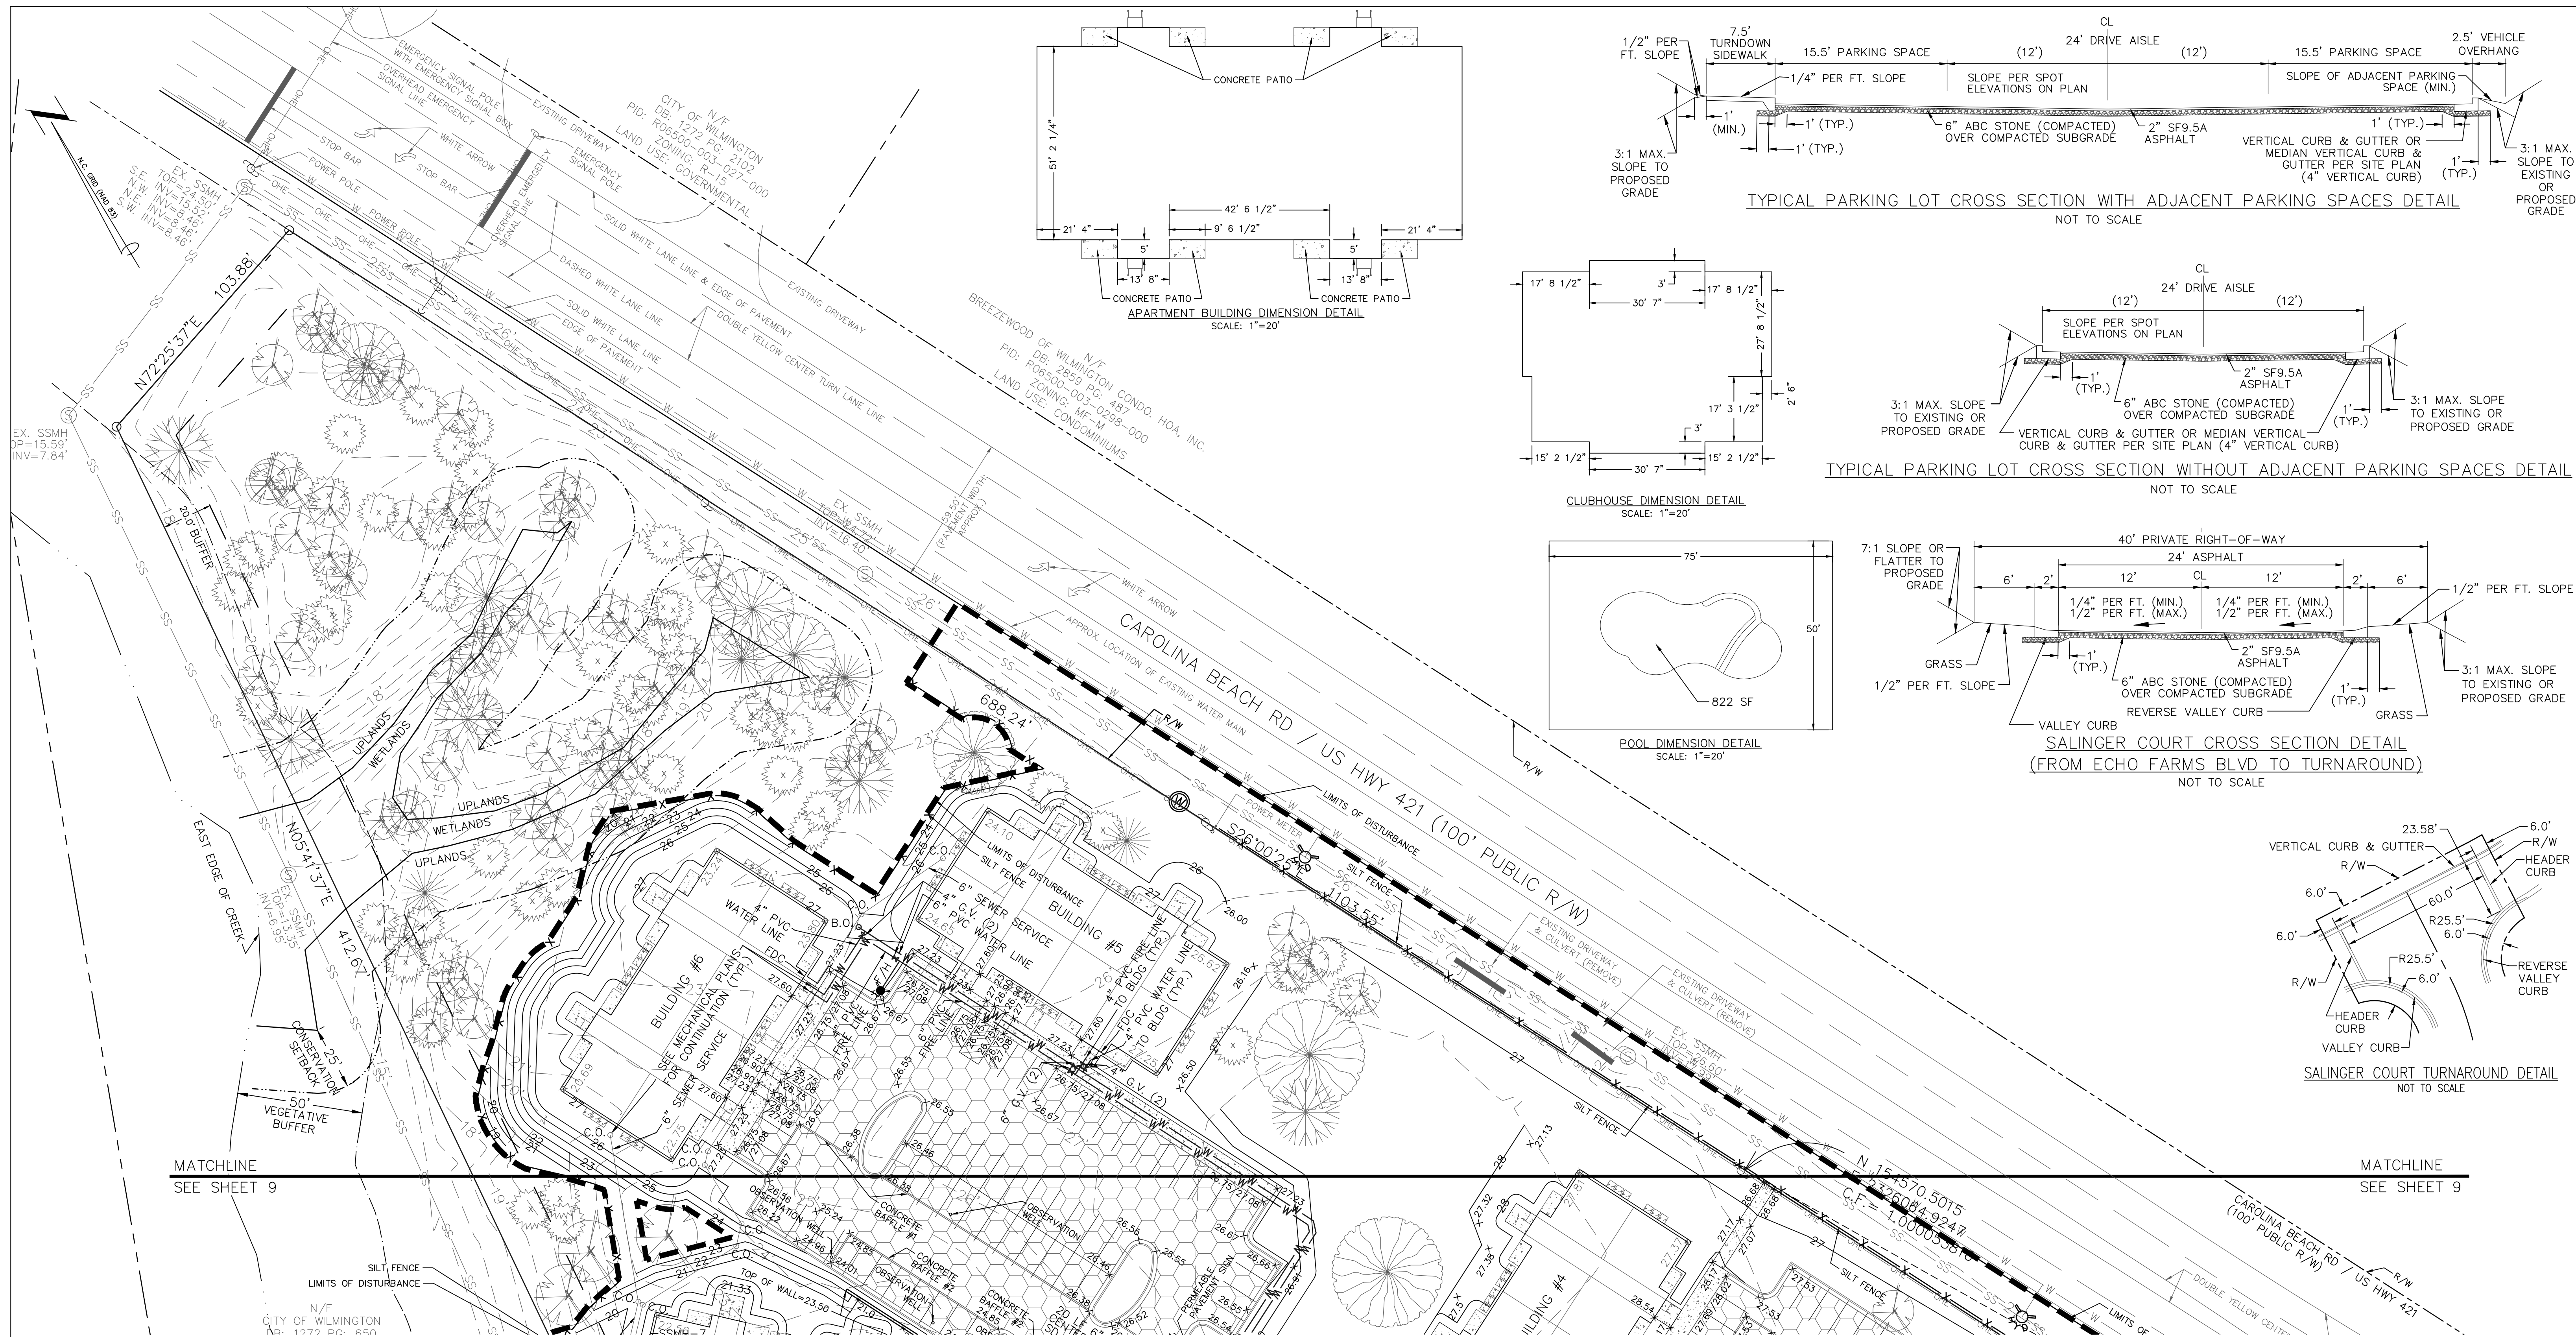

- UTILITY SEPARATION NOTES**
1. WATER MAINS SHALL HAVE A MINIMUM COVER OF 3'.
 2. SANITARY SEWER MAINS SHALL HAVE A MINIMUM COVER OF 3' OR D.I.P. SHALL BE USED.
 3. HORIZONTAL SEPARATION BETWEEN WATER AND SANITARY SEWER SHALL BE 10' BETWEEN EDGE OF PIPES.
 4. VERTICAL SEPARATION BETWEEN WATER AND SANITARY SEWER: WATER OVER SANITARY SEWER: >18" BETWEEN PIPES OR USE D.I.P. (ON BOTH) 10' ON EITHER SIDE OF CROSSING. SANITARY SEWER OVER WATER: USE D.I.P. (ON BOTH) 10' ON EITHER SIDE OF CROSSING.
 5. HORIZONTAL SEPARATION BETWEEN STORM SEWER & SANITARY SEWER SHALL BE 5' BETWEEN EDGE OF PIPES.
 6. A 24" VERTICAL SEPARATION BETWEEN PIPES SHALL BE PROVIDED BETWEEN STORM SEWER AND SANITARY SEWER. WHERE SEPARATION IS LESS THAN 24" & SANITARY IS OVER STORM USE D.I.P. ON SANITARY SEWER 10' ON EITHER SIDE OF CROSSING. WHERE SEPARATION IS LESS THAN 12" & STORM IS OVER SANITARY BRIDGING IS REQUIRED (SEE SANITARY SEWER DETAIL). WHERE SEPARATION IS 12"-24" & STORM IS OVER SANITARY BRIDGING OR D.I.P. ON SANITARY SEWER 10' ON EITHER SIDE OF CROSSING.
 7. HORIZONTAL SEPARATION BETWEEN WATER AND STORM SEWER SHALL BE 5' BETWEEN EDGE OF PIPES.
 8. VERTICAL SEPARATION BETWEEN WATER AND STORM SEWER: WATER OVER STORM SEWER: >18" BETWEEN PIPES OR USE D.I.P. ON WATER 10' ON EITHER SIDE OF CROSSING. STORM SEWER OVER WATER: USE D.I.P. ON WATER 10' ON EITHER SIDE OF CROSSING.
 9. ALL SANITARY SEWER MANHOLES WITH A DROP OF 30" OR GREATER SHALL HAVE AN INSIDE DIAMETER OF 5' WITH AN INSIDE DROP STRUCTURE.
 10. GRAVITY SANITARY SEWER WITHIN 50' OF WETLANDS SHALL BE D.I.P. AND MEET WATER MAIN MATERIALS, TESTING METHODS AND ACCEPTABILITY STANDARDS (15A NCAC 18C).
 11. SANITARY SEWER MANHOLES MUST BE GREATER THAN 50' FROM WETLANDS, AS MEASURED TO THE CLOSEST OUTSIDE EDGE.

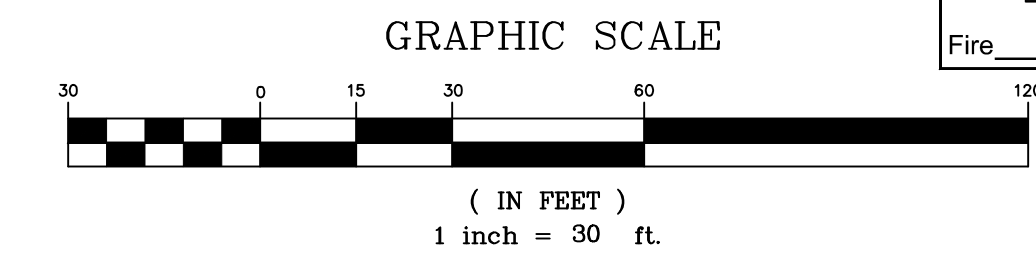

REV NO.	DESCRIPTION	DATE
1	REVISED FOR SRB SUBMITTAL	8-2-15
2	REVISED FOR EROSION CONTROL SUBMITTAL	10-1-15
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PRELIMINARY PLAT
NOT FOR RECORDATION,
CONVEYANCES, OR SALES

Approved Construction Plan

Name _____ Date _____

Planning _____

Traffic _____

Fire _____

WILMINGTON
NORTH CAROLINA

Public Services • Engineering Division

APPROVED STORMWATER MANAGEMENT PLAN

Date: _____ Permit # _____

Signed: _____

EROSION CONTROL, STORMWATER, & UTILITY PLAN
4010 CAROLINA BEACH ROAD


ECHO FARM APARTMENTS

WILMINGTON TOWNSHIP NEW HANOVER COUNTY NORTH CAROLINA


FINAL DRAWING FOR REVIEW PURPOSES ONLY

Developer: ECHO FARM APARTMENTS, LLC
10 S. CAROLINA DRIVE
WILMINGTON, NORTH CAROLINA 28403
PHONE: 910-251-5030


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PROJECT NO: 260
SHEET NO: 10
OF: 22

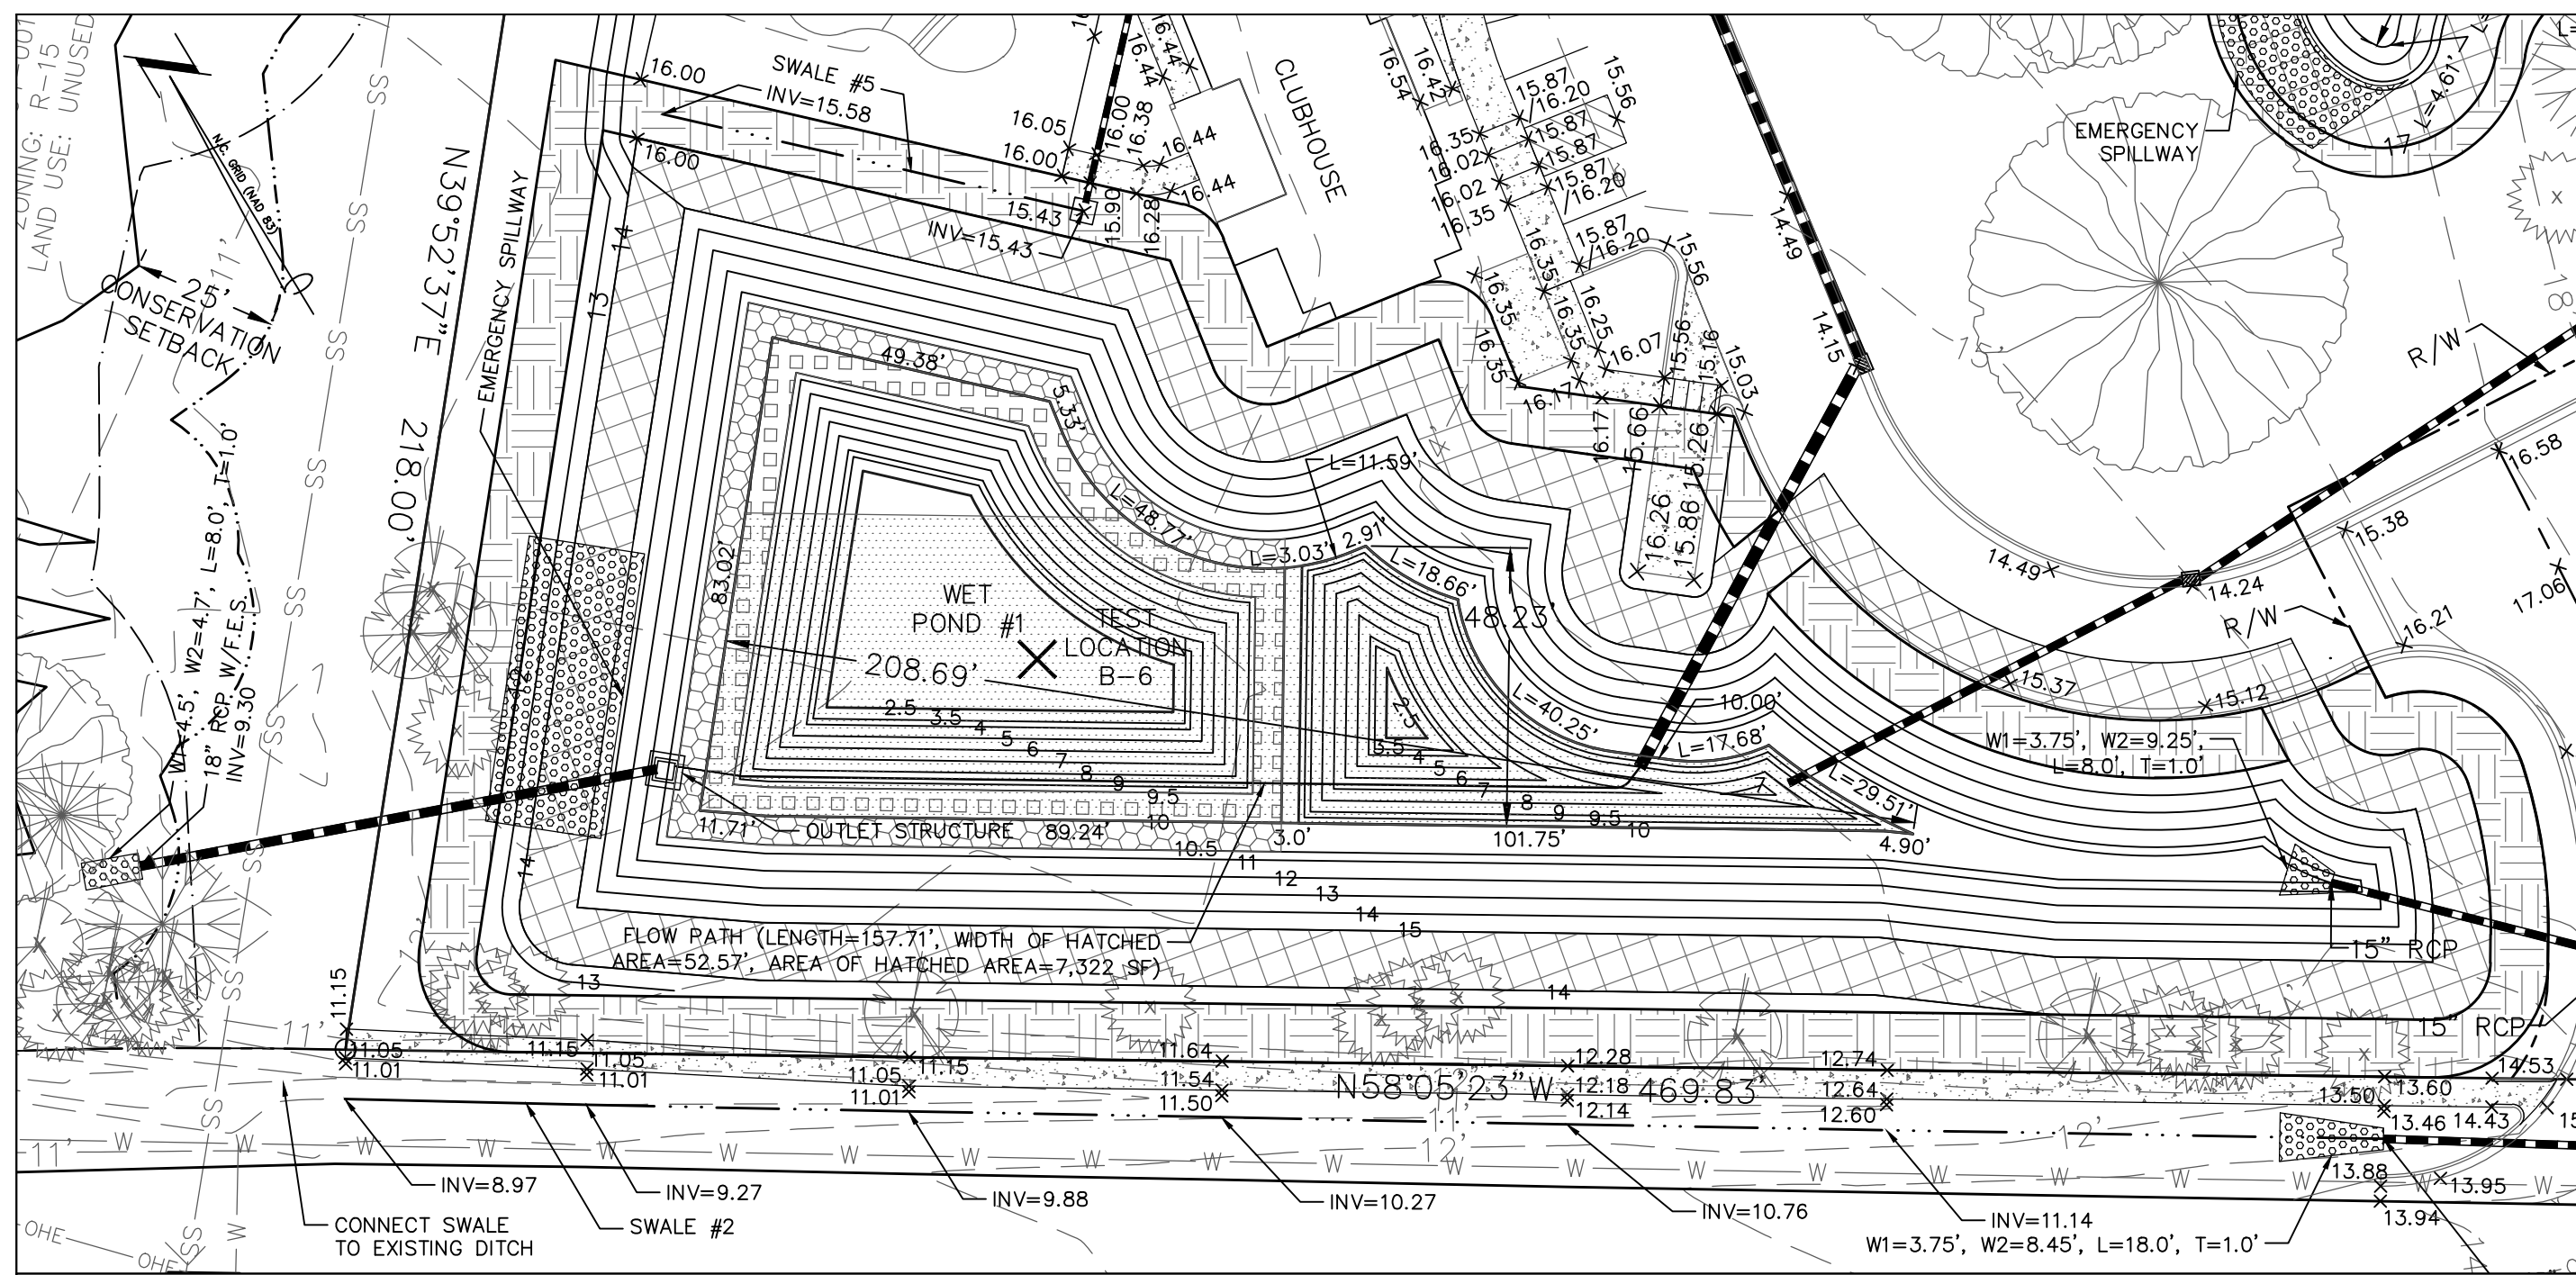


WET POND #1 DETAIL
SCALE: 1"=30'

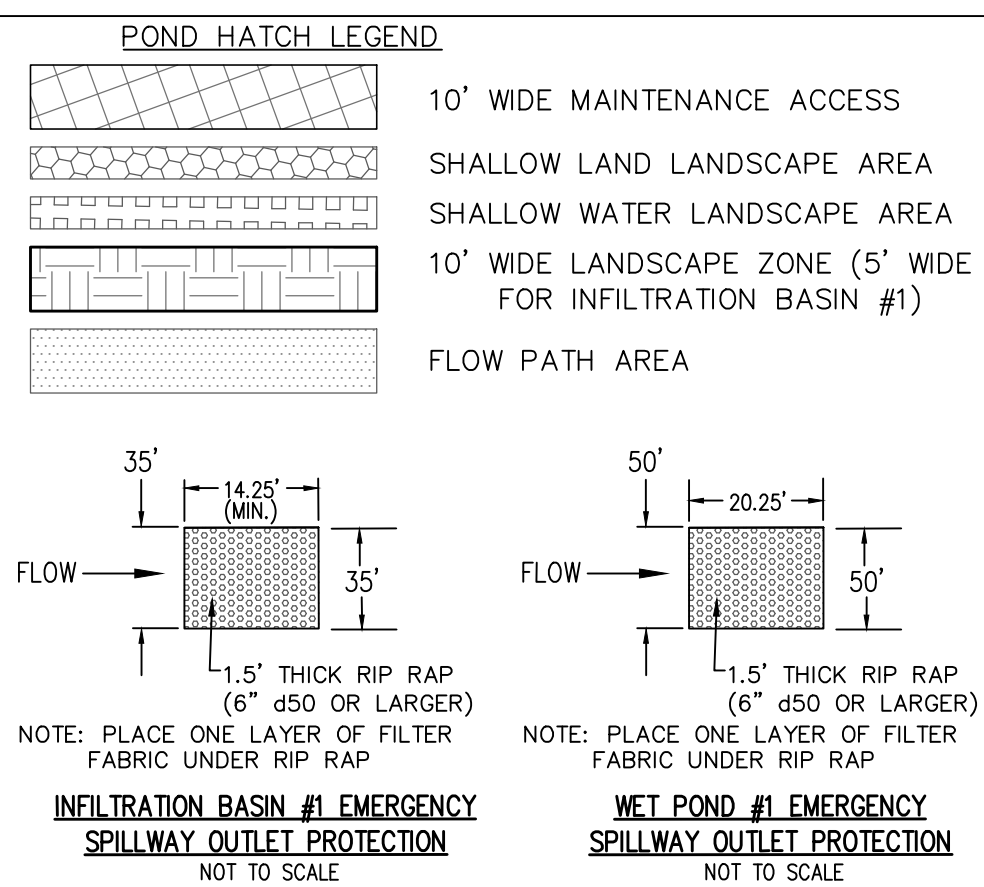


POND HATCH LEGEND

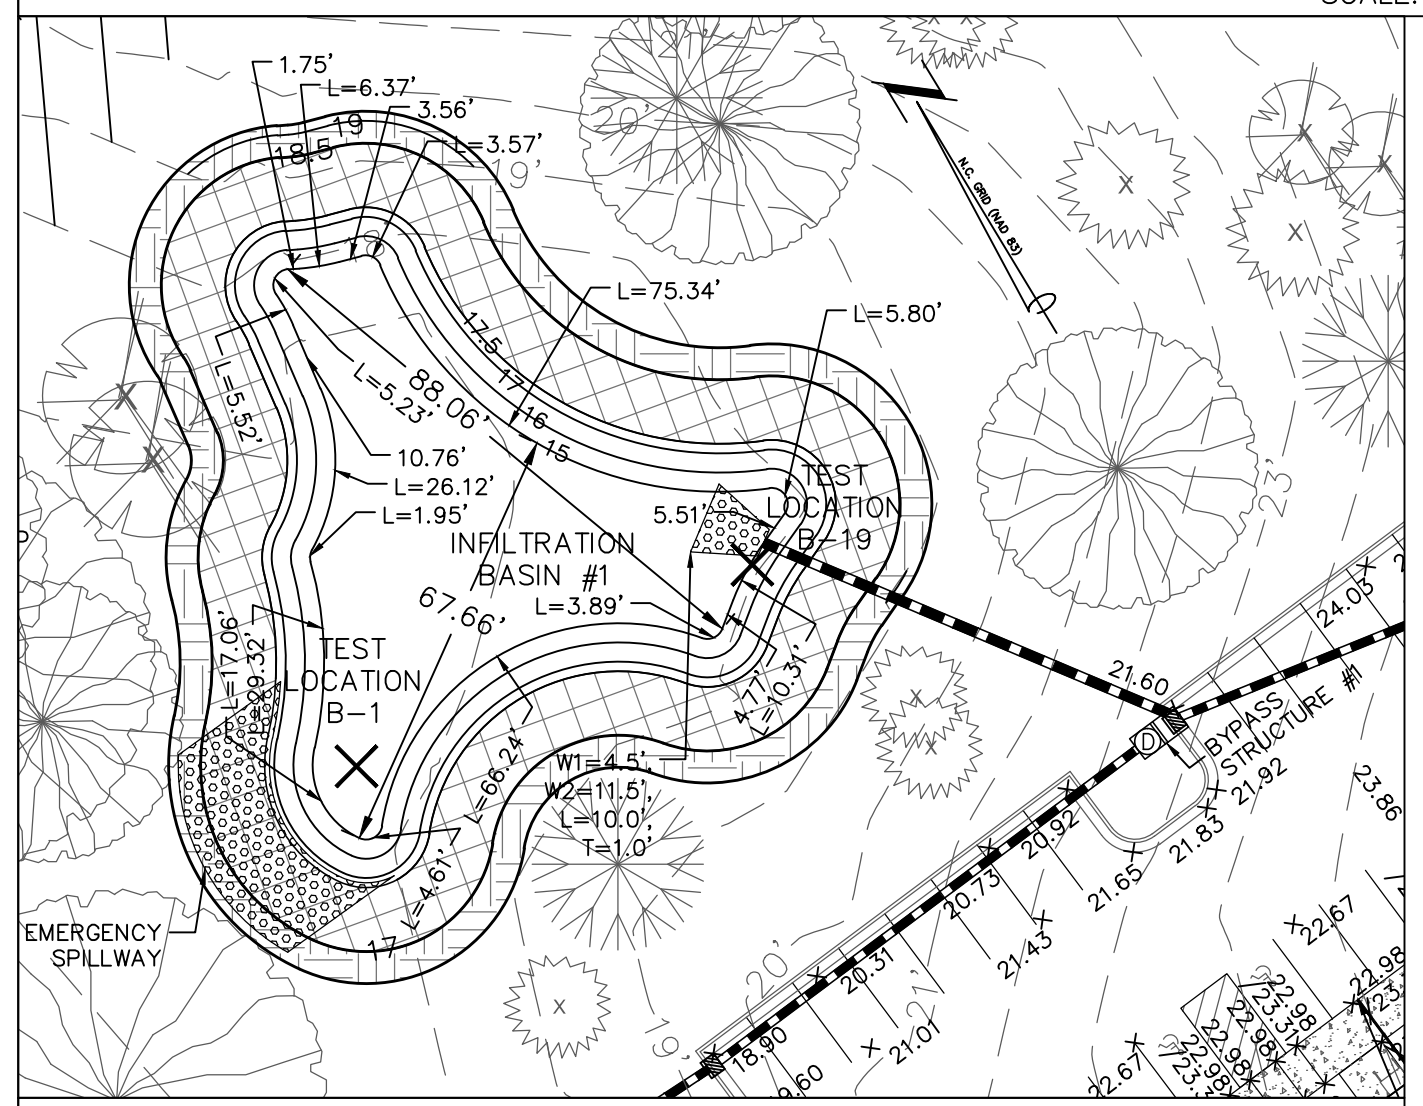

INFILTRATION BASIN #1 DETAIL
SCALE: 1"=30'

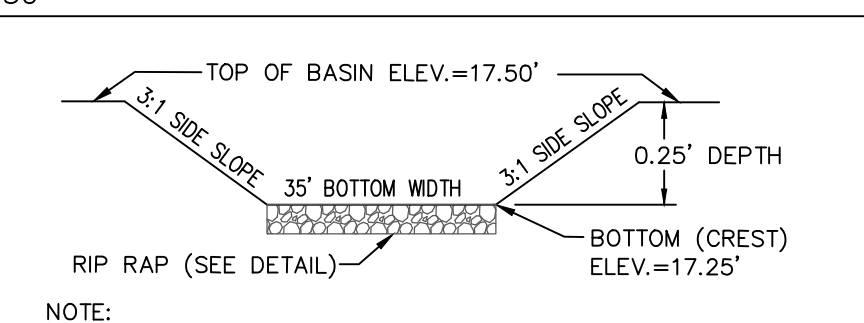

INFILTRATION BASIN #1 EMERGENCY SPILLWAY CROSS SECTION DETAIL
NOT TO SCALE

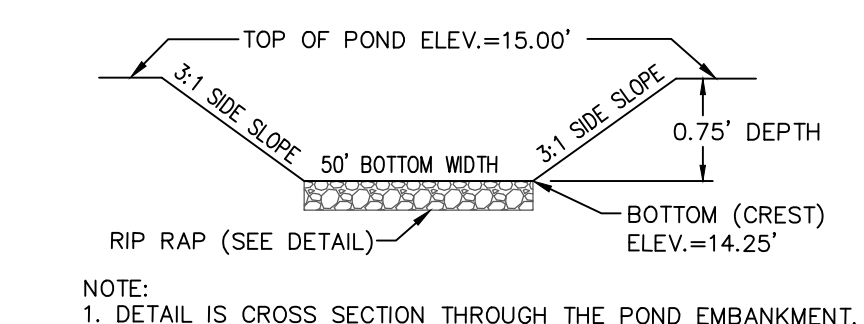

WET POND #1 EMERGENCY SPILLWAY CROSS SECTION DETAIL
NOT TO SCALE

SEASONAL HIGH WATER TABLE RESULTS

TEST LOCATION ID	EXISTING GROUND ELEVATION (FEET)*	SHWT (INCHES BELOW GROUND SURFACE)**	SHWT ELEVATION (FEET)**
B-1	16.60	48	12.60
B-2	20.96	38	17.80
B-3	27.98	60	22.98
B-4	26.17	36	23.17
B-5	24.67	66	19.17
B-6	12.47	10	11.64
B-7	14.50	30	12.00
B-8	14.79	36	11.79
B-9	18.18	60	13.18
B-10	27.03	48	23.03
B-11	25.73	16	24.40
B-12	25.47	18	23.97
B-13	26.32	36	23.32
B-14	25.48	48	21.48
B-15	25.71	42	22.21
B-16	25.48	42	21.98
B-17	24.73	42	21.23
B-18	25.57	44	21.91
B-19	17.76	66	12.26
B-20	27.02	52	22.69
B-21	27.05	50	22.89
B-22	26.29	38	23.13
B-23	26.30	42	22.80


* INFORMATION PROVIDED BY BATEMAN CIVIL SURVEY COMPANY, PC.
** INFORMATION PROVIDED BY ECS CAROLINAS, LLP.
*** CALCULATED BASED ON INFORMATION PROVIDED BY OTHERS

WET POND #1


ELEV. (FT)	AREA (SQ. FT.)	INCREMENTAL VOLUME (CU. FT.)	CUMULATIVE VOLUME (CU. FT.)
10.00	8,713	0	0
10.50	11,799	5,128	5,128
11.00	12,867	6,166	11,294
12.00	15,068	13,968	25,262
13.00	17,351	16,209	41,471
14.00	19,720	18,536	60,007
15.00	22,178	20,949	80,956

INFILTRATION BASIN #1


ELEV. (FT)	AREA (SQ. FT.)	INCREMENTAL VOLUME (CU. FT.)	CUMULATIVE VOLUME (CU. FT.)
15.00	2,925	0	0
15.50	3,364	1,572	1,572
16.00	3,817	1,795	3,367
16.50	4,283	2,025	5,392
17.00	4,764	2,262	7,654
17.50	5,260	2,506	10,160

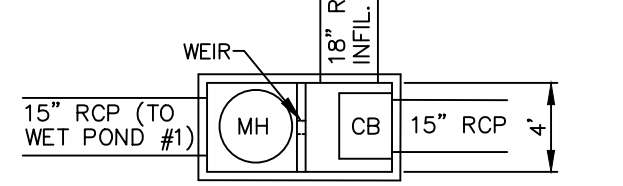

BYPASS STRUCTURE #1 DETAIL
NOT TO SCALE

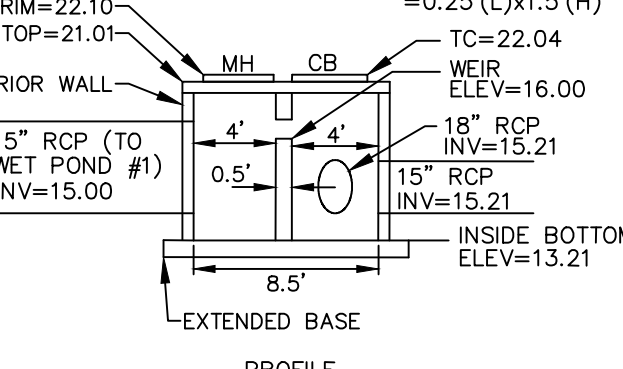


BYPASS STRUCTURE #1 DETAIL
NOT TO SCALE

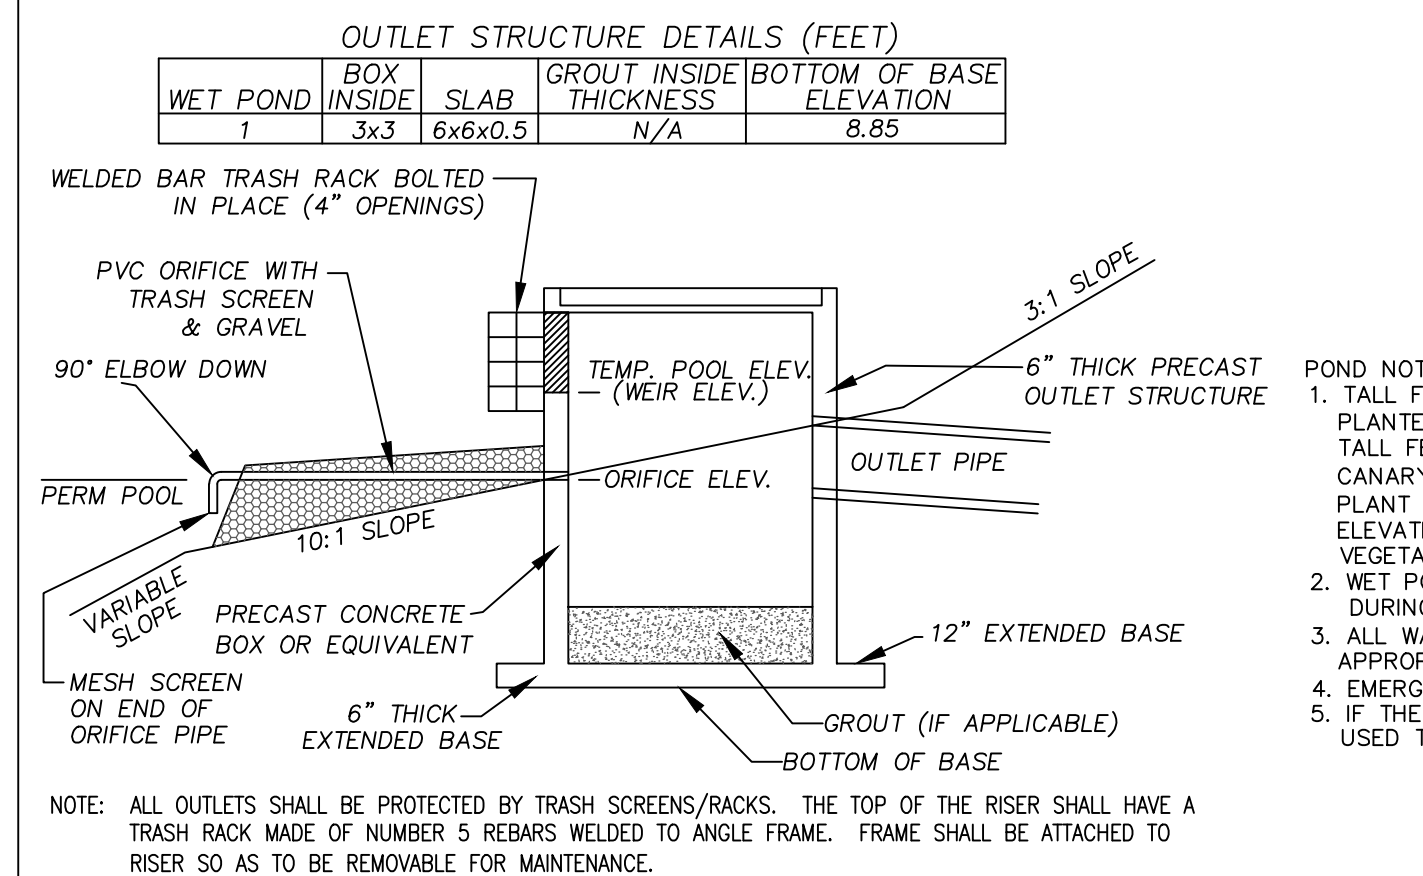


OUTLET STRUCTURE DETAIL
NOT TO SCALE

- POND NOTES:
- TALL FESCUE, BERBERIS GRASS, PENSACOLA BAHIA GRASS, OR REED CANARY GRASS SHALL BE PLANTED ON SLOPES OF WET POND #1 ABOVE ELEVATION=10.50'.
 - TALL FESCUE, BERBERIS GRASS, PENSACOLA BAHIA GRASS, REED CANARY GRASS, OR ANY SHALLOW LAND PLANT VARIETIES FROM THE VEGETATIVE SHELF PLANT SCHEDULE SHALL BE PLANTED AROUND THE FOREBAY IN WET POND #1 FROM ELEVATION=10.00' TO 10.50'. SEE VEGETATIVE SHELF PLANT SCHEDULE FOR PLANTING OF VEGETATIVE SHELF (HATCHED AREA).
 - WET POND #1 SHALL BE USED AS A SEDIMENT BASIN WITH A FAIRLOTH SKIMMER ORIFICE DURING CONSTRUCTION. IT SHALL BE CLEANED OUT PRIOR TO USE AS A WET POND.
 - ALL WATER THAT DRAINS OFF IMPERVIOUS SURFACES SHALL BE DIRECTED INTO THE APPROPRIATE STORMWATER SYSTEM (SEE DRAINAGE AREA MAPS).
 - EMERGENCY SPILLWAY & ENERGY DISSIPATOR TO HAVE FILTER FABRIC UNDERLAYMENT.
 - IF THE POND NEEDS TO BE DRAINED FOR MAINTENANCE OR AN EMERGENCY A PUMP SHALL BE USED TO DRAIN IT.

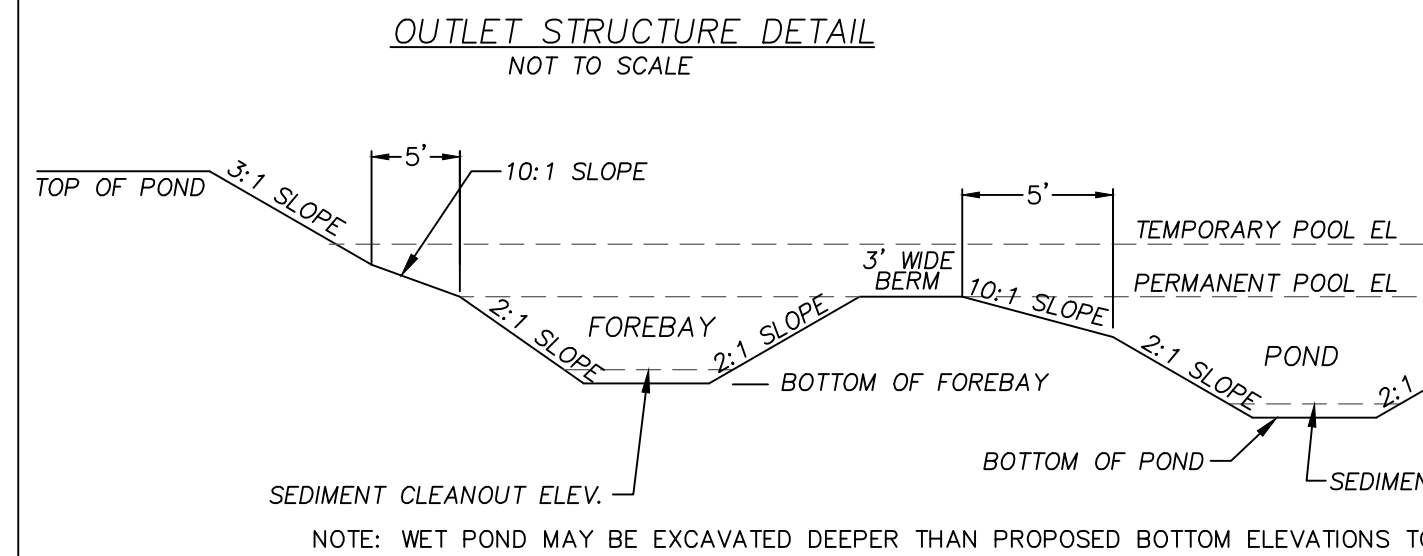

WET POND #1-FOREBAY & POND SECTION DETAIL
NOT TO SCALE

WET POND	TOP PERM. TEMP. POOL	PERM. POOL	TEMP. POOL	VEGETATED SHELF	FOREBAY TOP	FOREBAY BOTTOM	POND TOP	POND BOTTOM	SEDIMENT CLEANOUT EL.	SEDIMENT CLEANOUT EL.	OUTLET STRUCTURE ELEVATIONS	EMERGENCY SPILLWAY	IMPERVIOUS AREAS (SQUARE FEET)	BUILDINGS	PARKING	SIDEWALKS	OTHER	OFFSITE	TOTAL		
1	15.00	10.00	11.20	9.50-10.50	2.50	2.50	3.50	3.50	13.75	0.5	1.25 @ 11.20	N/A	1.5' @ 10.00	18" RCP @ 9.85	50' @ 14.25	30,773	64,690	8,373	4,838	N/A	108,674

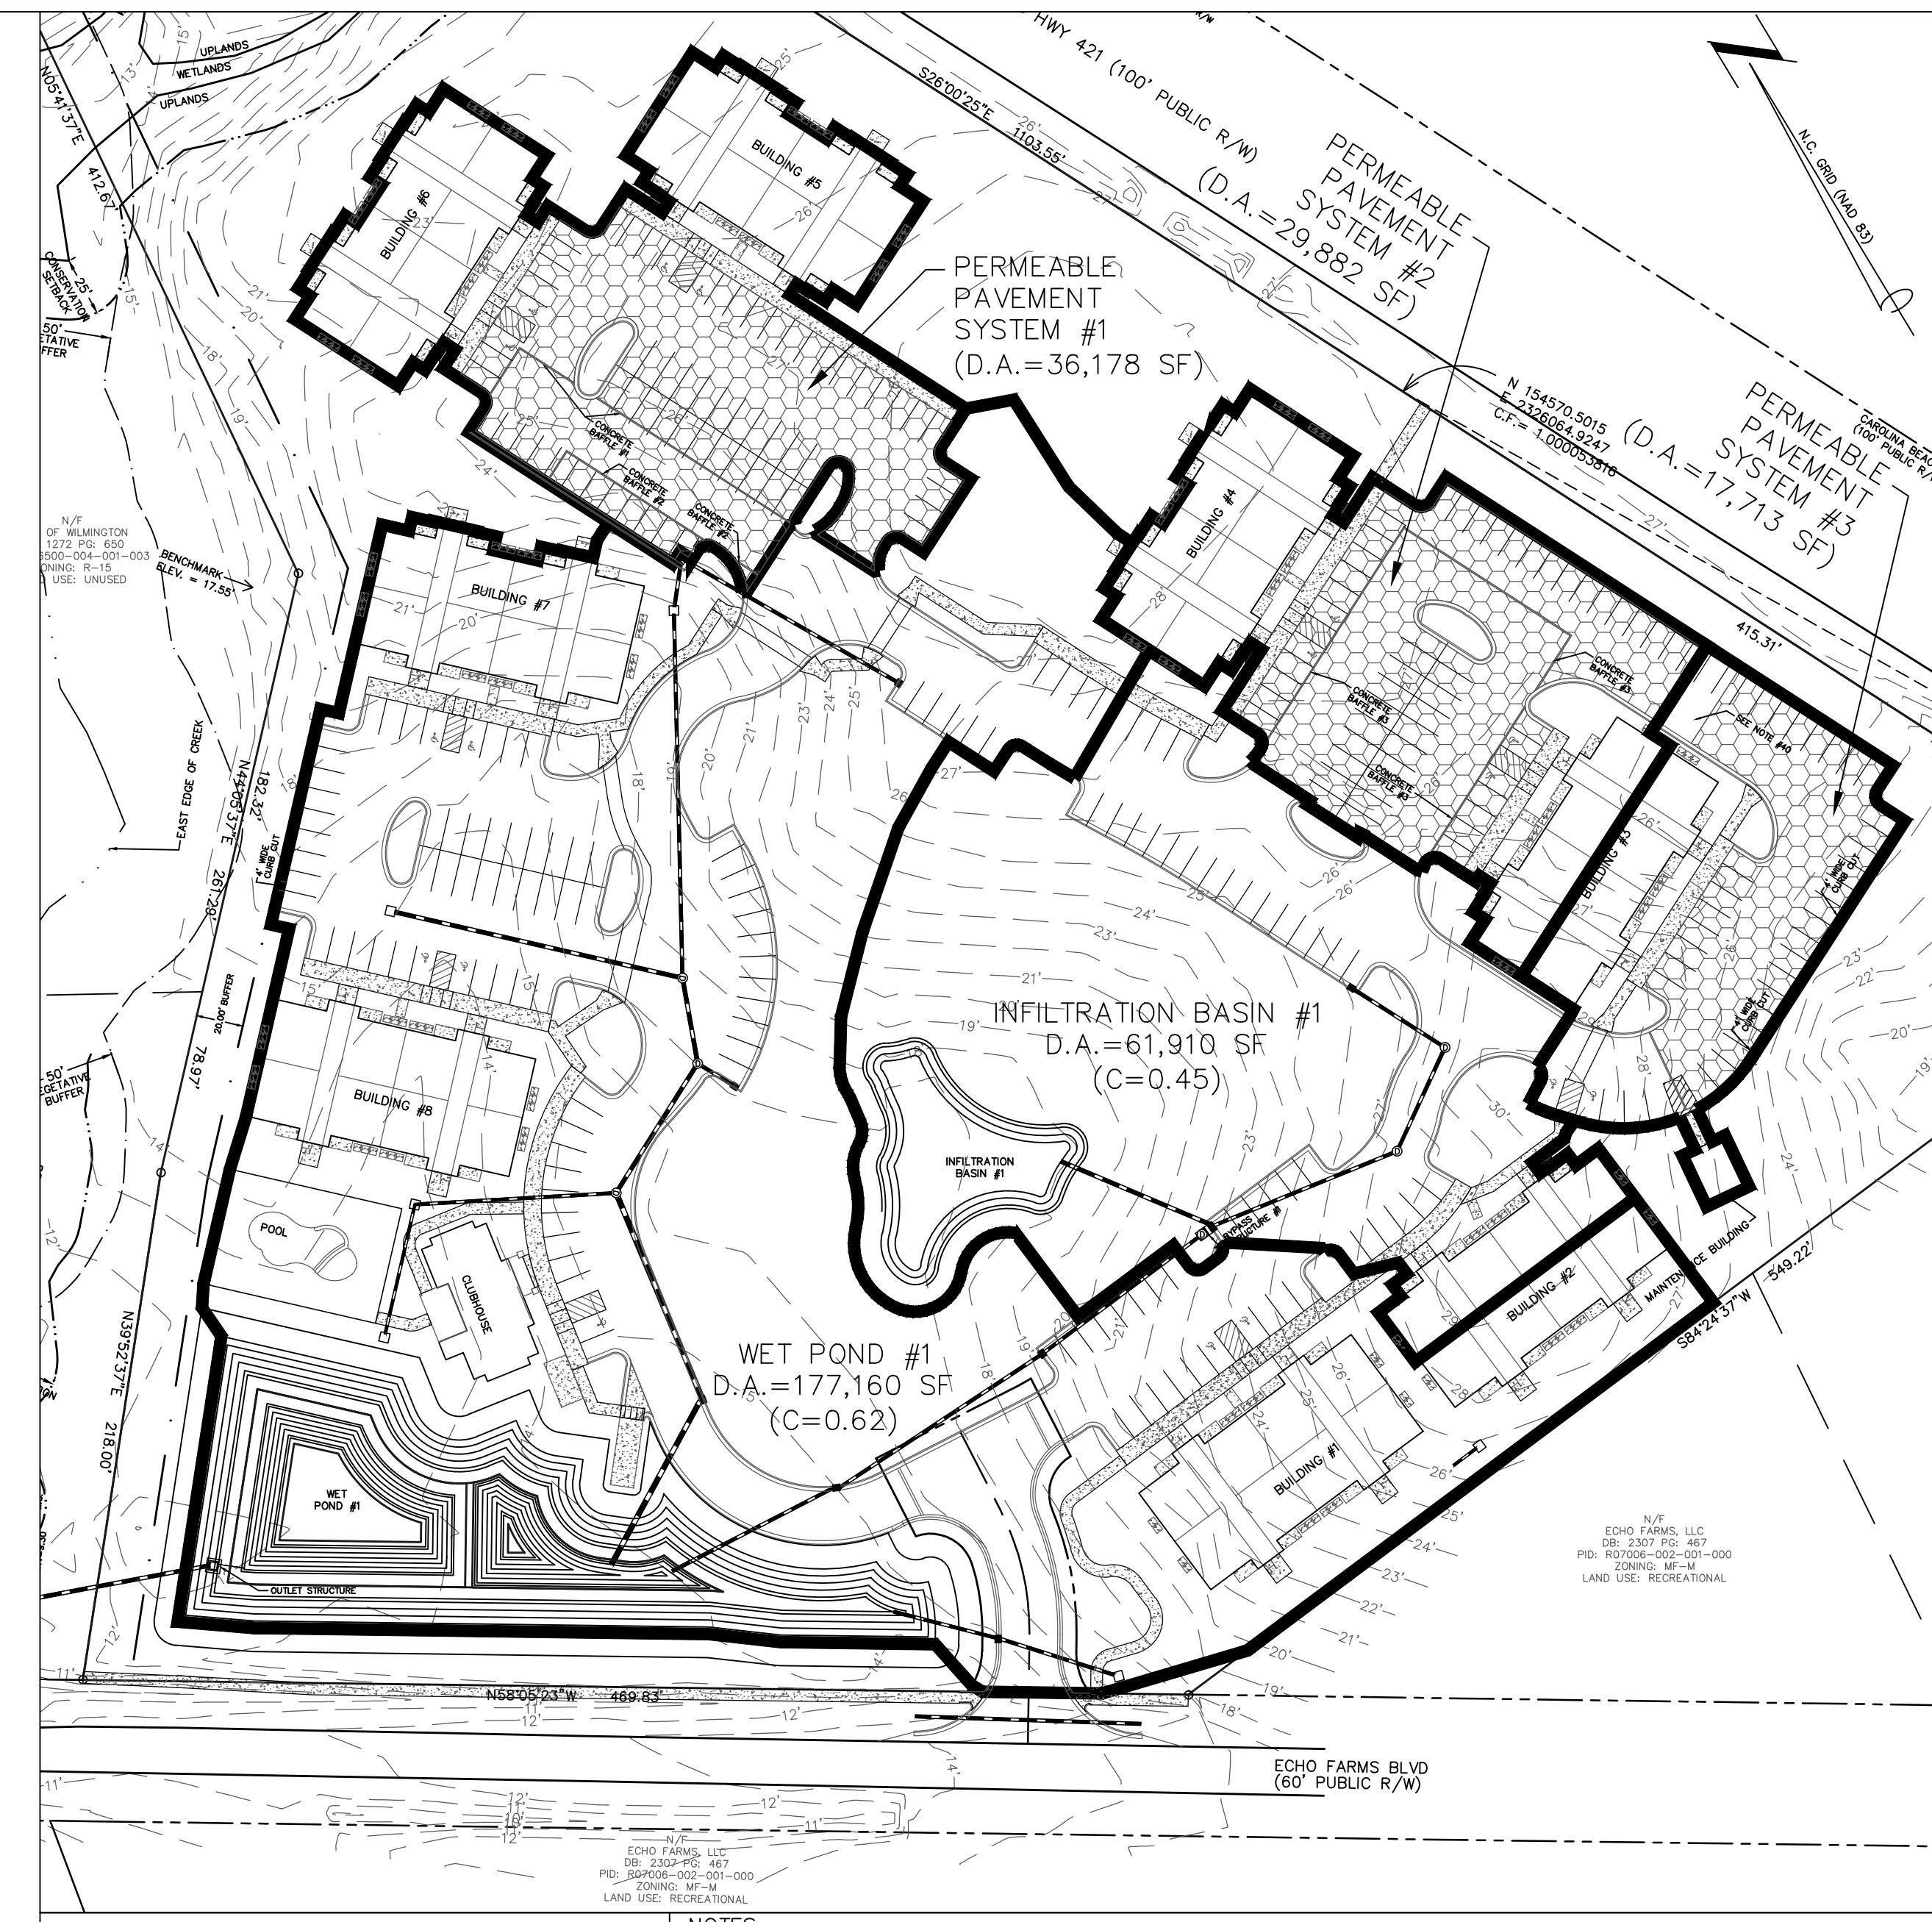

BMP DRAINAGE AREA MAP
SCALE: 1"=60'

- NOTES:
- D.A. OF PERMEABLE PAVEMENT SYSTEMS EXCLUDE ANY PVIOUS AREA SHOWN WITHIN D.A. BOUNDARY.
 - D.A. OF WET POND #1 EXCLUDES D.A. OF INFILTRATION BASIN #1.

VEGETATIVE SHELF PLANT SCHEDULE

LOCATION	PLANT VARIETIES BOTANICAL NAME (COMMON NAME)	SPACING	SIZE	HATCHED SHELF AREA (SF)	PLANTINGS REQUIRED (MIN. 50 PER 200 SF)	PLANTINGS PROVIDED (MIN. 50 PER 200 SF)
*SHALLOW WATER (VEGETATIVE SHELF BELOW PERMANENT POOL ELEVATION; ELEV.=9.50' TO ELEV.=10.00')	<i>Acorus subcordatus</i> (Sweetflag), <i>Alisma subcordatum</i> (Water plantain), <i>Hydrocotyle quadrivalvis</i> (Waterpocket), <i>Iris virginica</i> (Blue flag iris), <i>Ajuncus effusus</i> var. <i>pyrei</i> or <i>solutus</i> (Soft rush), <i>Ludwigia</i> spp. (Primrose willow), <i>Peltandra virginica</i> (Arrow arum), <i>Pontederia cordata</i> (Pickerelweed), <i>Sagittaria latifolia</i> (Duck Potato), <i>Sagittaria lancifolia</i> (Bulltongue), <i>Saururus cernuus</i> (Lizard's tail), <i>Scheuchzeria palustris</i> (Soft stem bulrush), <i>Scheuchzeria palustris</i> (Three-square bulrush), <i>Scirpus operinus</i> (Woolgrass), <i>Zizaniopsis miliacea</i> (Giant cutgrass)	2' O.C. STAGGERED	5-6" PLUG	1,554.90	389	389
**SHALLOW LAND (VEGETATIVE SHELF ABOVE PERMANENT POOL ELEVATION; ELEV.=10.00' TO ELEV.=10.50')	<i>Asclepias incarnata</i> (Swamp Milkweed), <i>Carex tenera</i> (Quill sedge), <i>Chelone glabra</i> (White Turtlehead), <i>Eupatoriadelphus dubius</i> (Dwarf Joe Pye Weed), <i>Eupatoriadelphus fistulosus</i> (Joe Pye Weed), <i>Eupatoriadelphus maculatus</i> (Spotted trumpetweed), <i>Hibiscus coccineus</i> (Scarlet rose mallow), <i>Hibiscus laevis</i> (Habeard leaf rosemallow), <i>Kosteletzkya virginica</i> (Seashore Mallow), <i>Lobelia cardinalis</i> (Cardinal flower), <i>Lobelia elongata</i> (longleaf lobelia), <i>Lobelia siphilitica</i> (Great blue Lobelia), <i>Rhynchospora colorata</i> (Starrush whitetop), <i>Sorghastrum nutans</i> (Narrow plume grass)	2' O.C. STAGGERED	5-6" PLUG	1,490.12	373	373

- *AT LEAST 3 DIFFERENT SHALLOW WATER PLANT VARIETIES MUST BE PLANTED.
**AT LEAST 3 DIFFERENT SHALLOW LAND PLANT VARIETIES MUST BE PLANTED.

Approved Construction Plan

Name _____ Date _____

Public Services • Engineering Division

APPROVED STORMWATER MANAGEMENT PLAN

Date: _____ Permit # _____

Signed: _____

EROSION CONTROL & STORMWATER DETAIL SHEET
4010 CAROLINA BEACH ROAD

ECHO FARM APARTMENTS
WILMINGTON TOWNSHIP NEW HANOVER COUNTY NORTH CAROLINA

DATE: 10-1-15
SCALE: VARIES
DRAWN: JCB
CHECKED: JEM
PROJECT NO: 260

MALPASS ENGINEERING & SURVEYING, P.C.
1134 SHIPYARD BOULEVARD
WILMINGTON, NORTH CAROLINA 28412
Phone 910-392-5243 Fax 910-392-5203 License No. C-2320

Developer: ECHO FARM APARTMENTS, LLC
10 S. CARDINAL DRIVE
WILMINGTON, NORTH CAROLINA 28403
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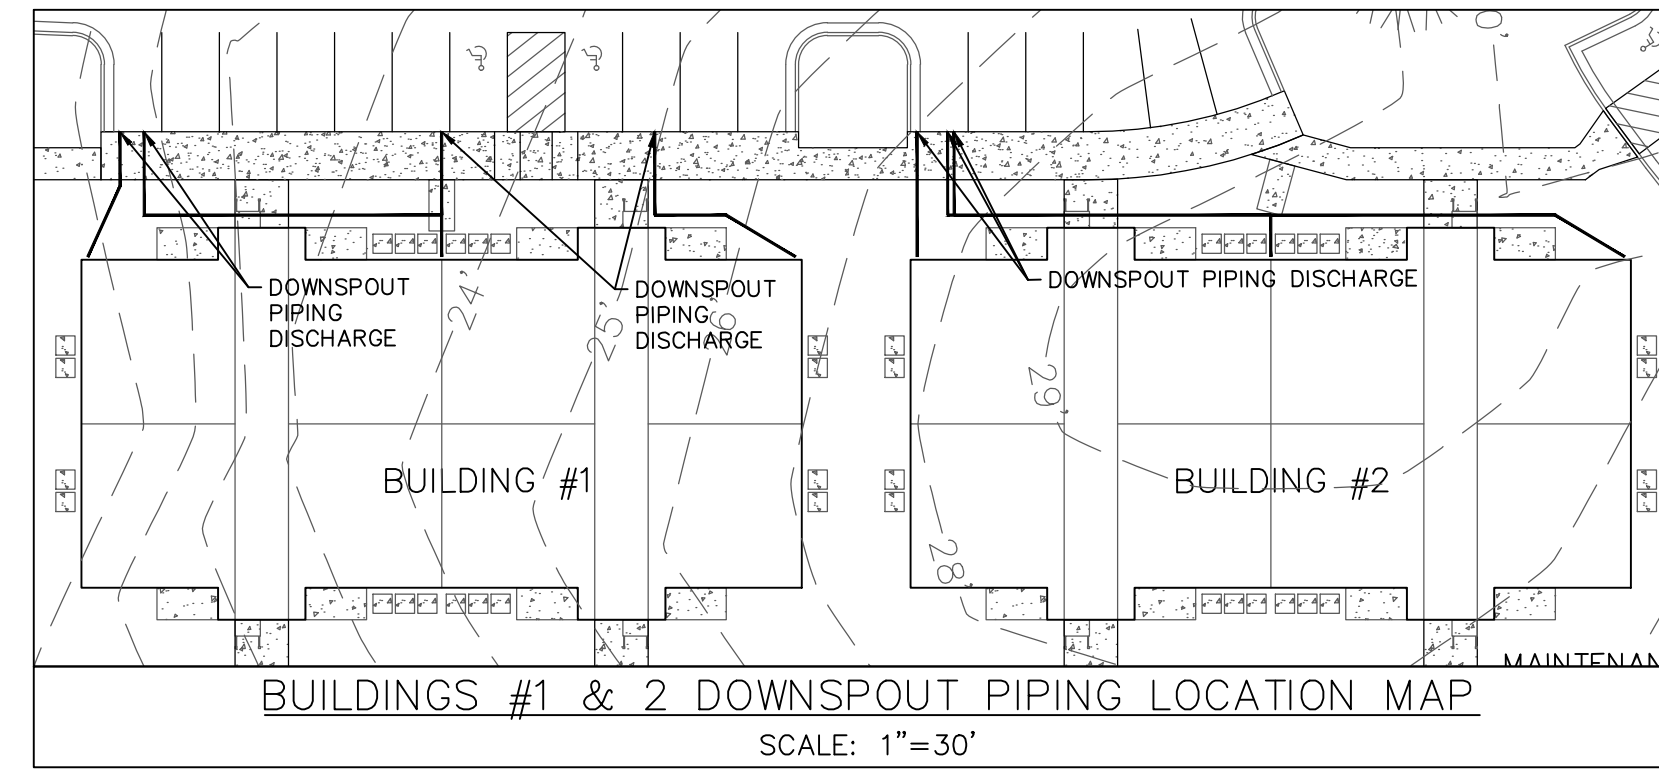
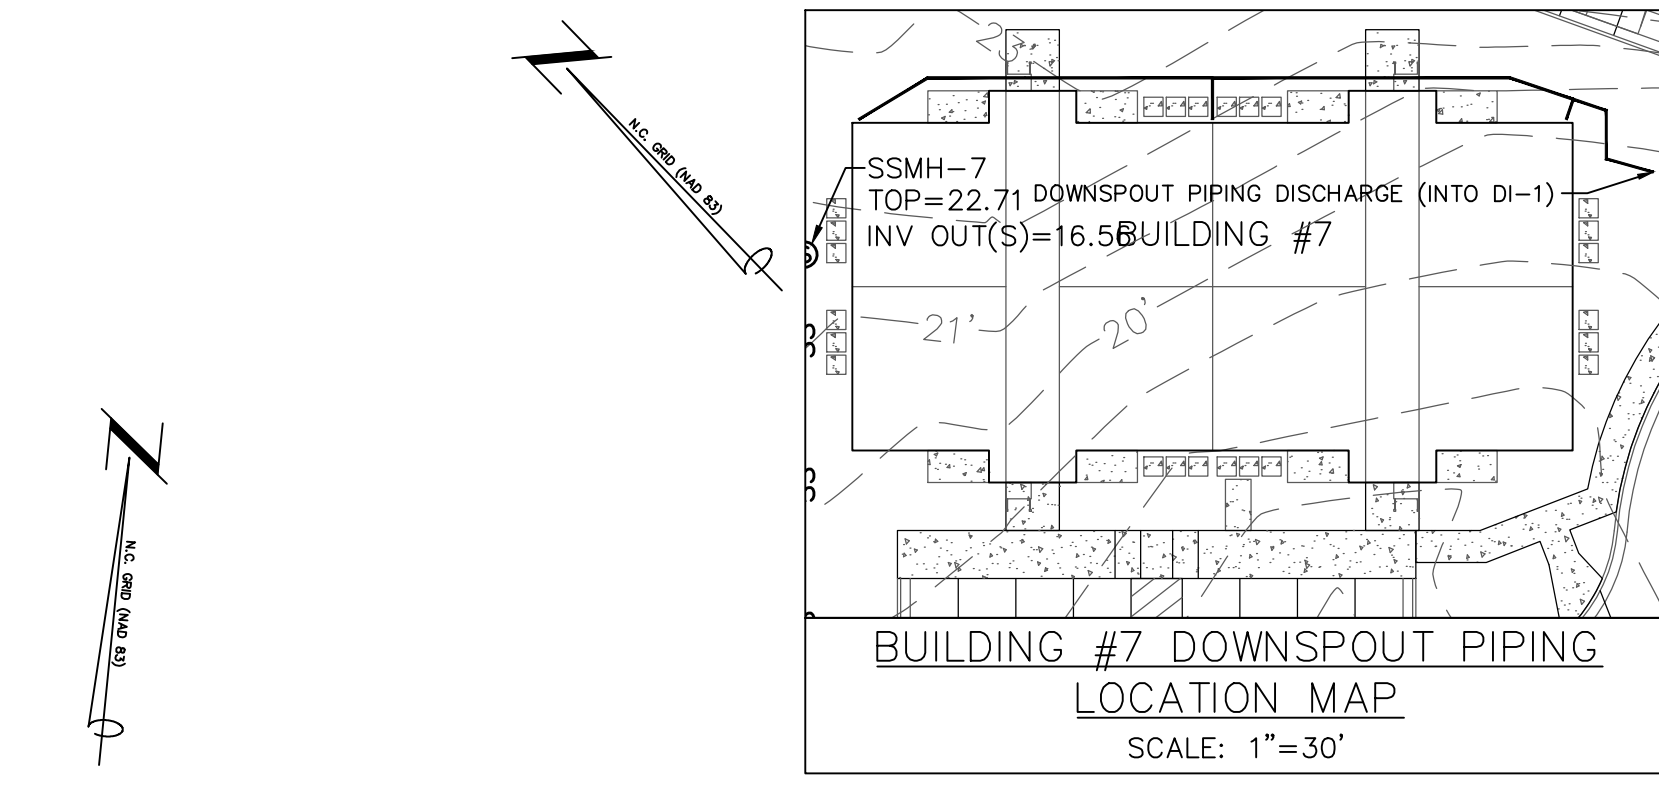
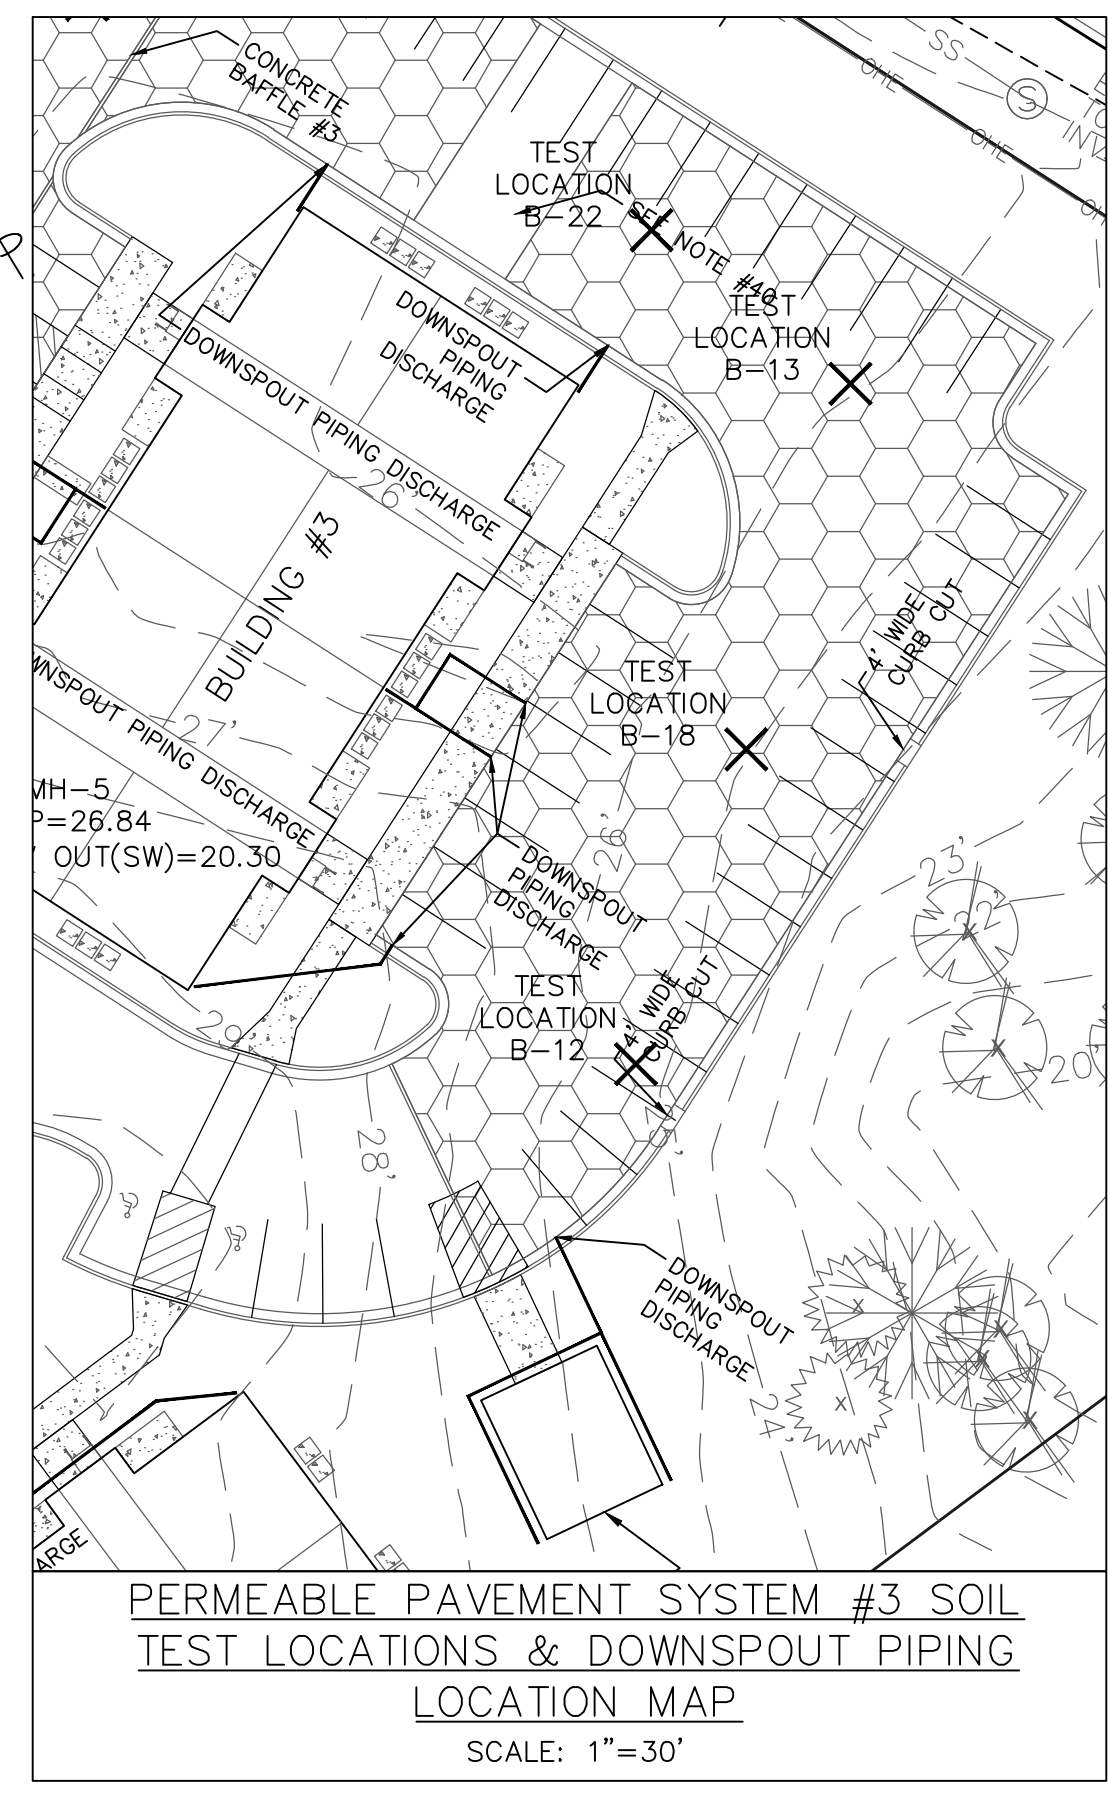
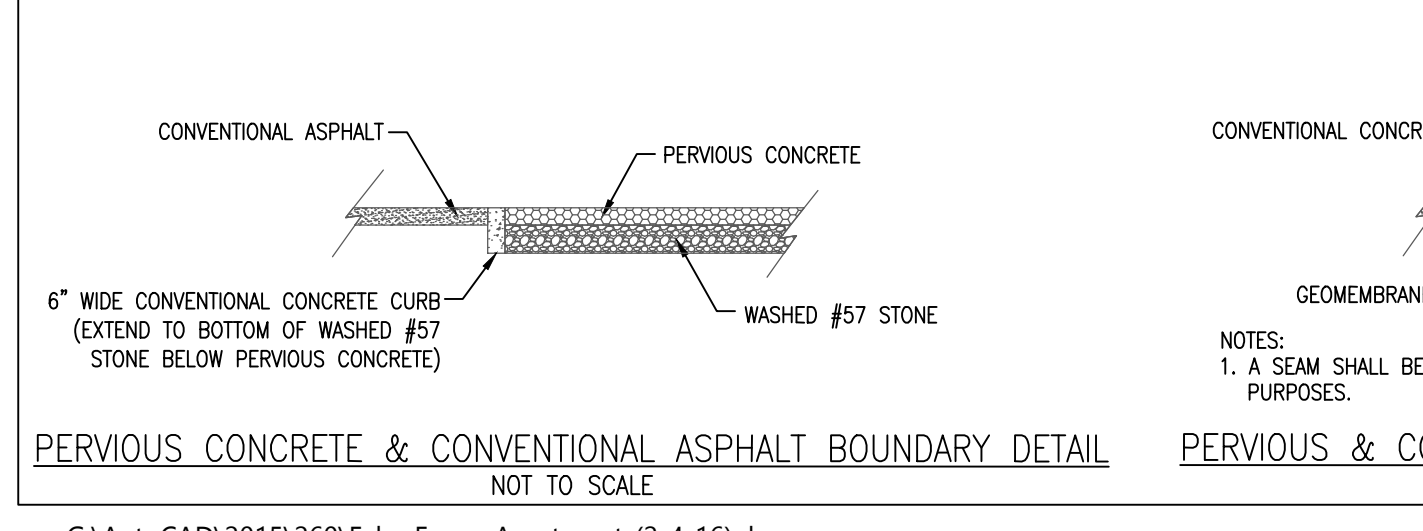
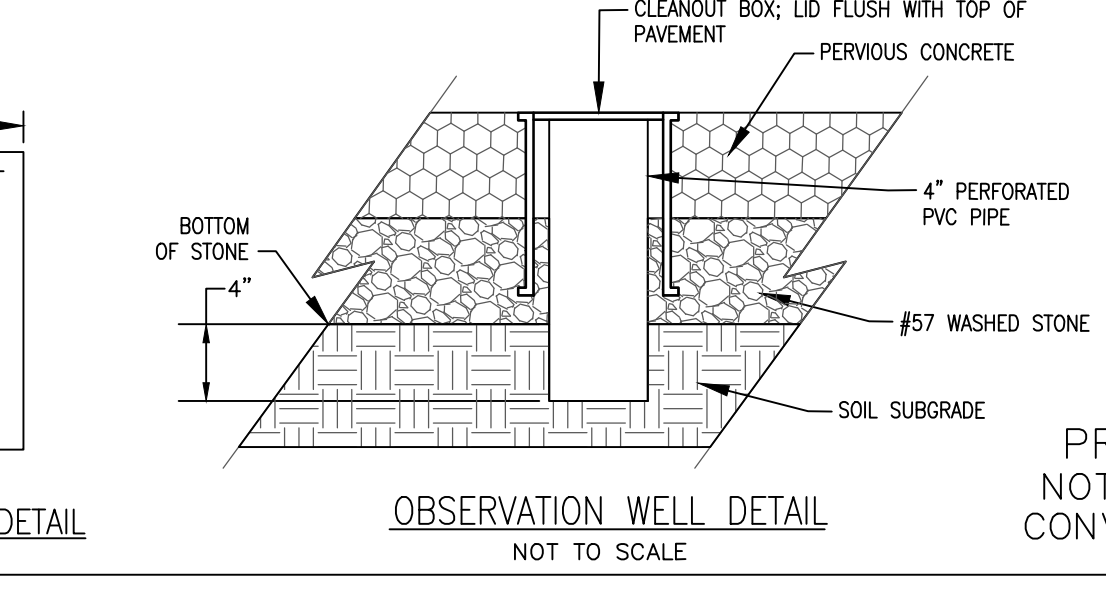
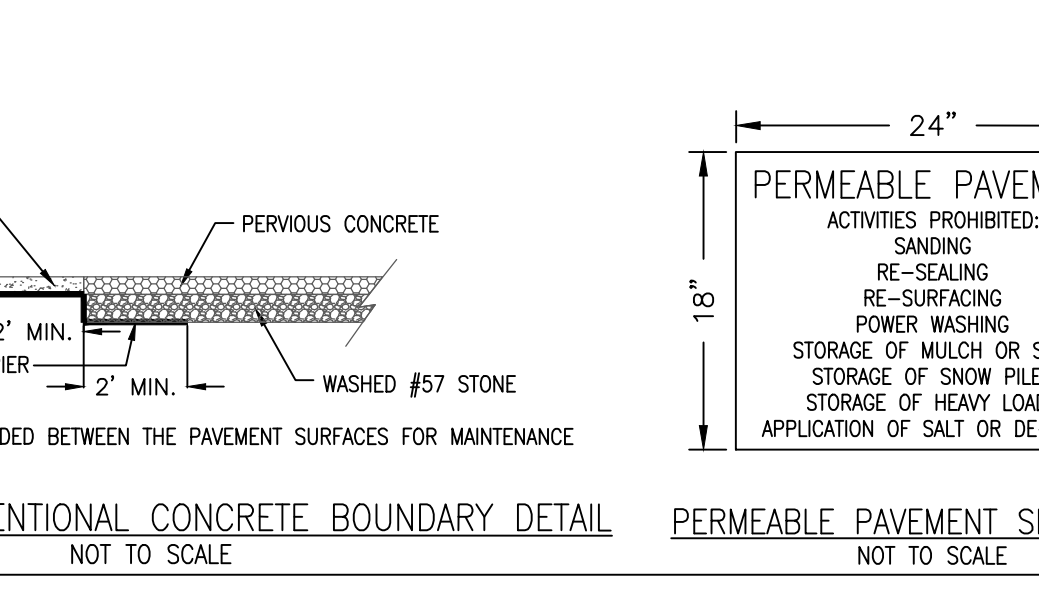
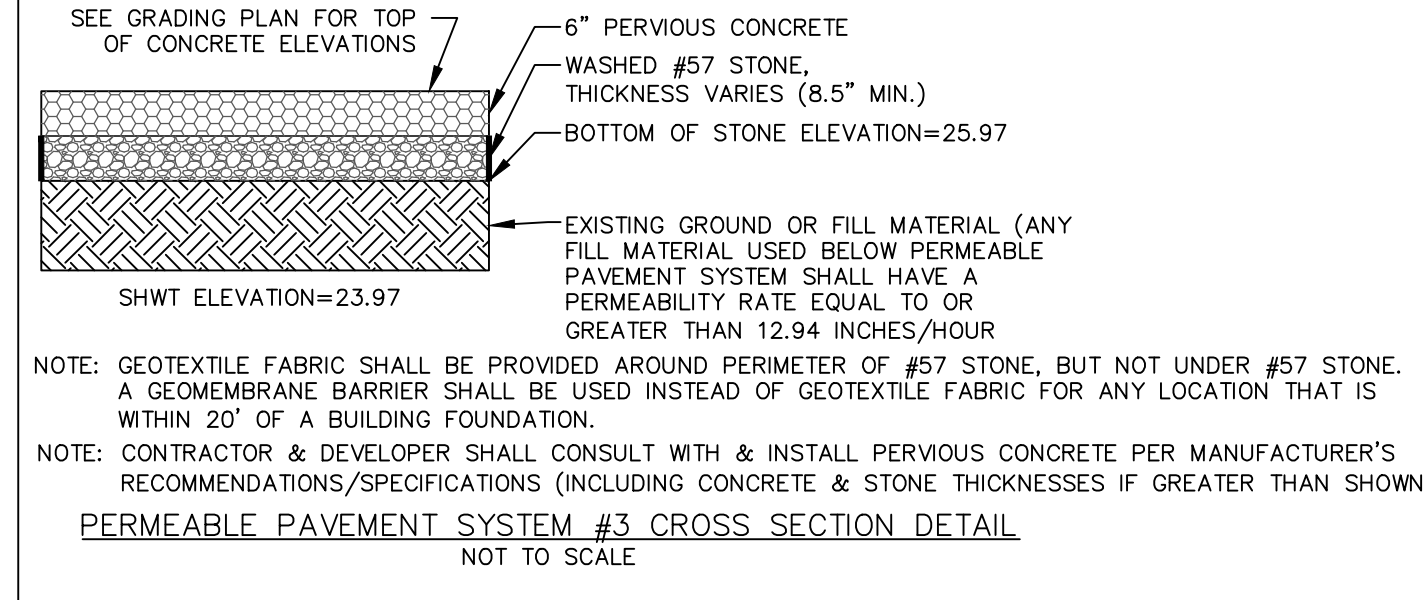
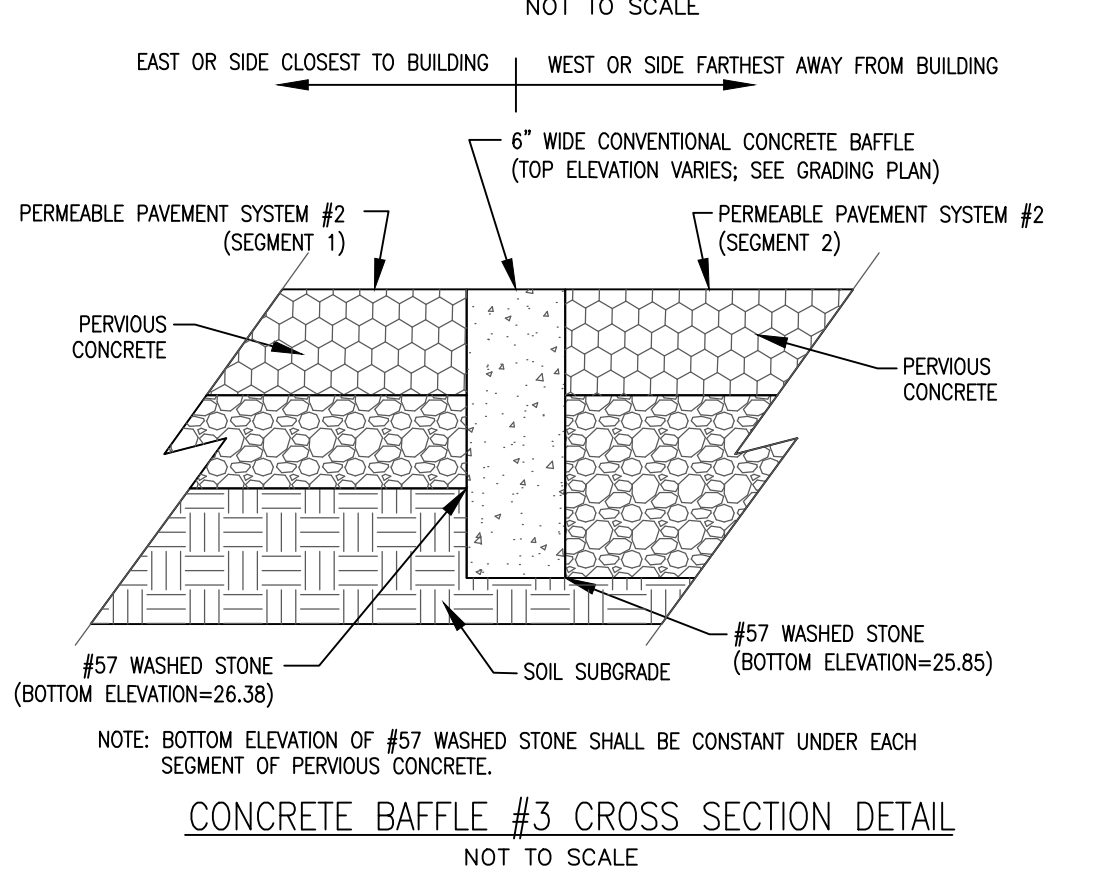
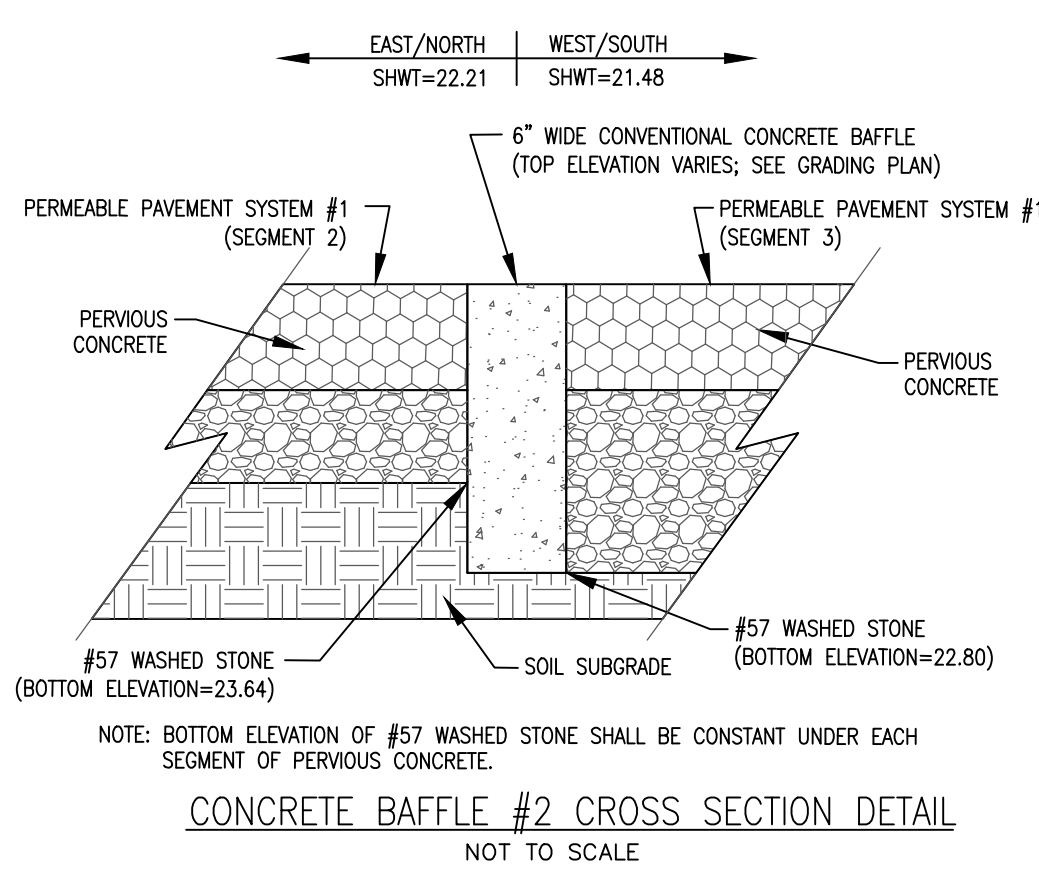
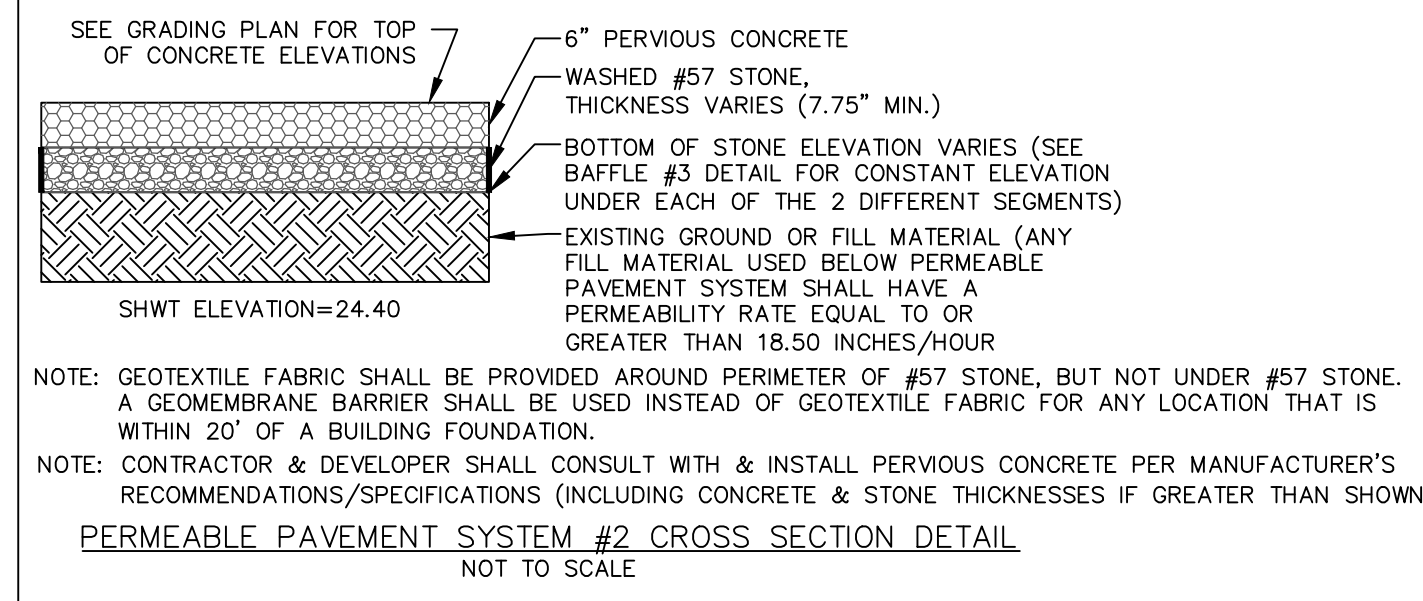
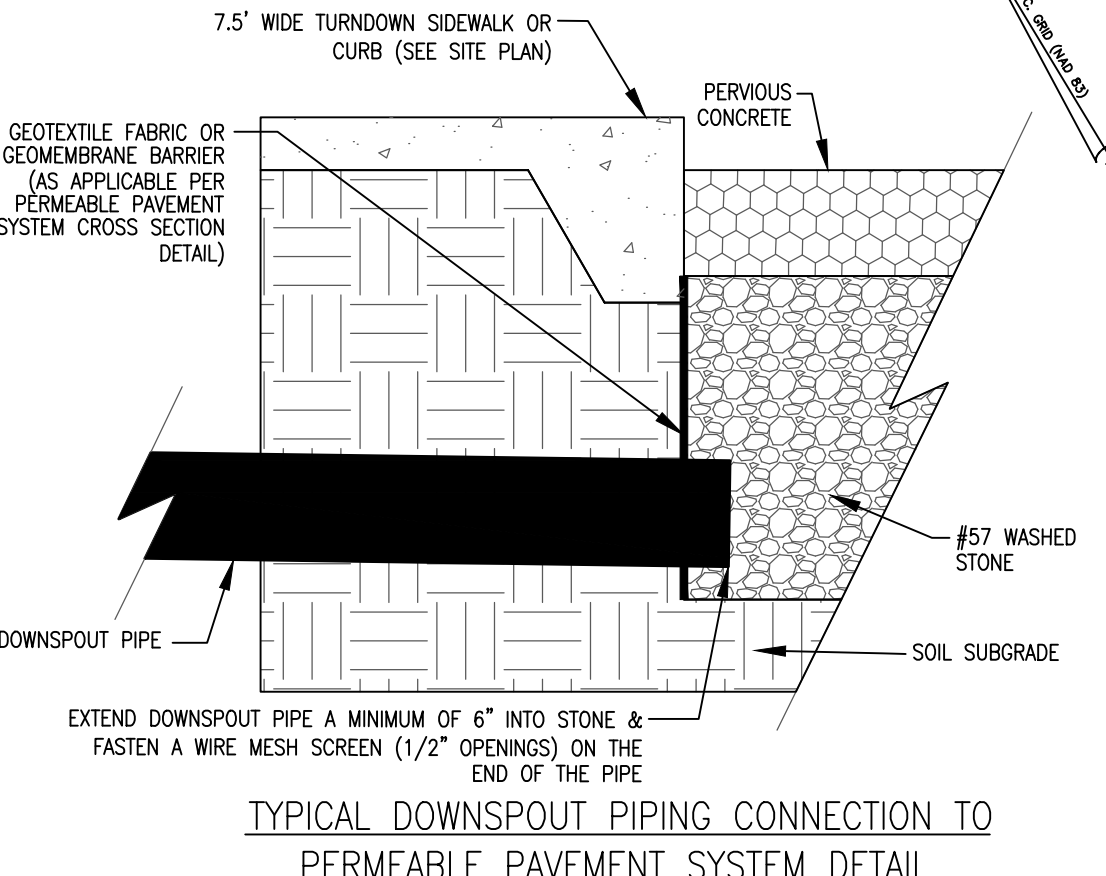
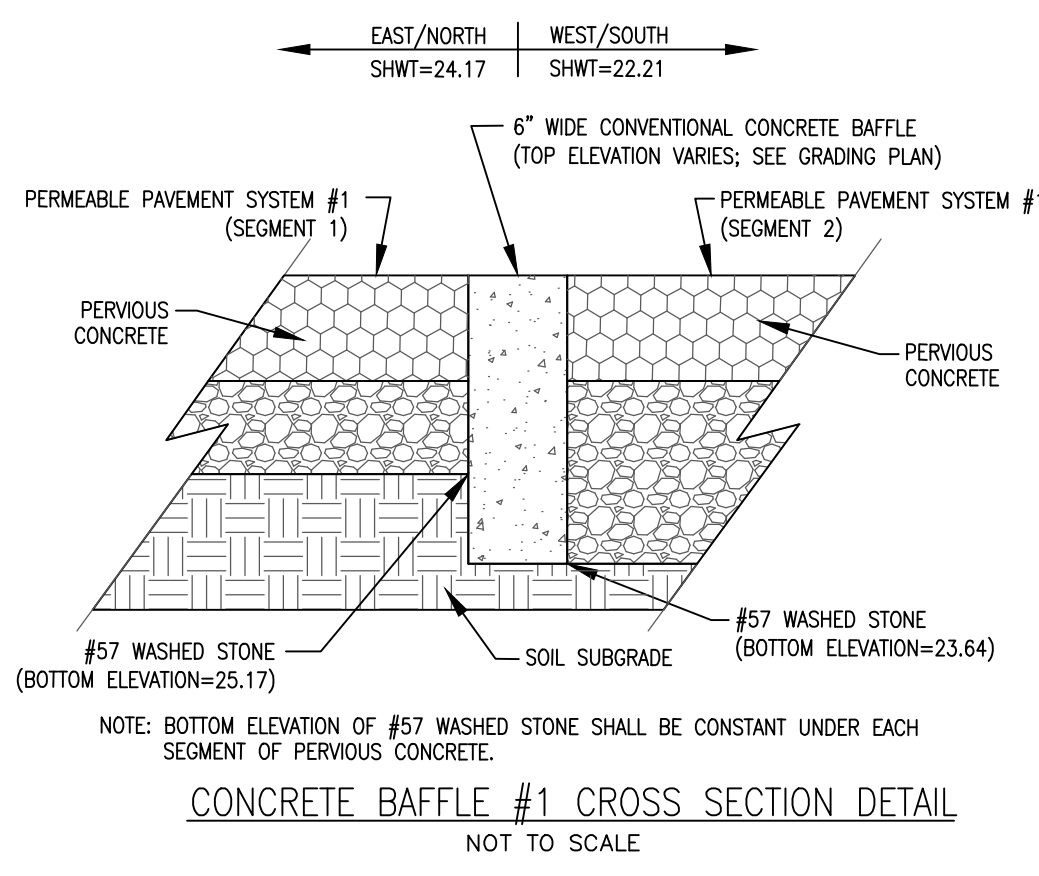
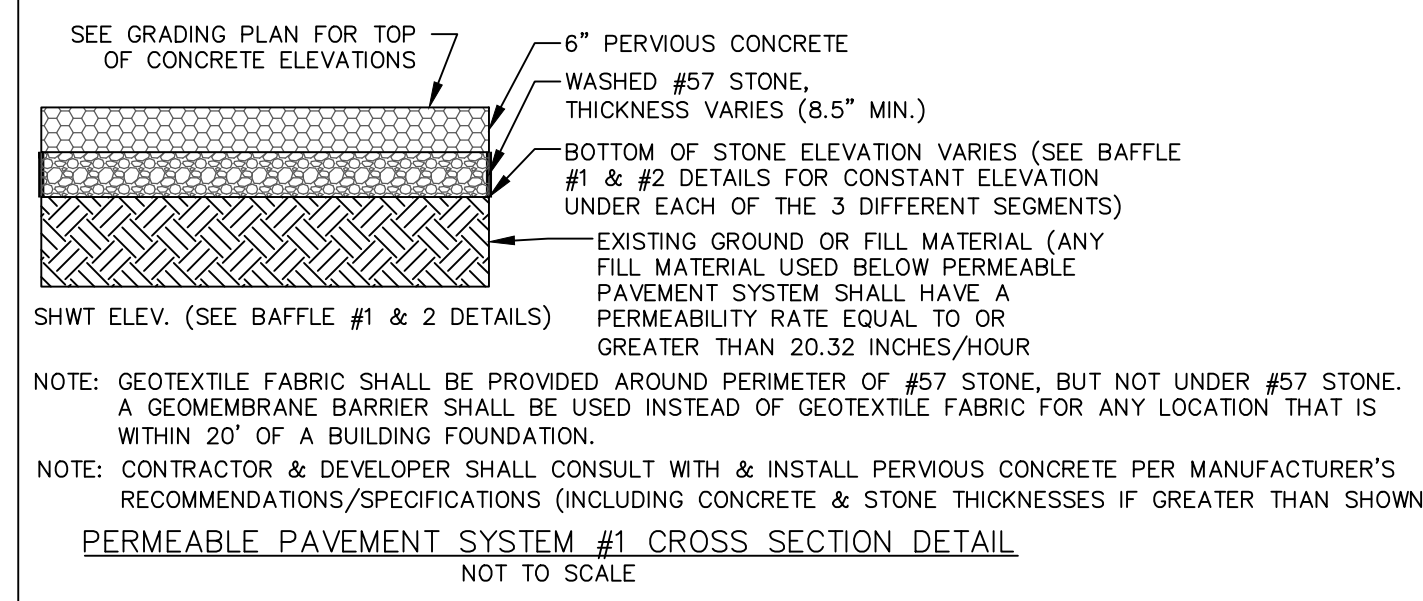
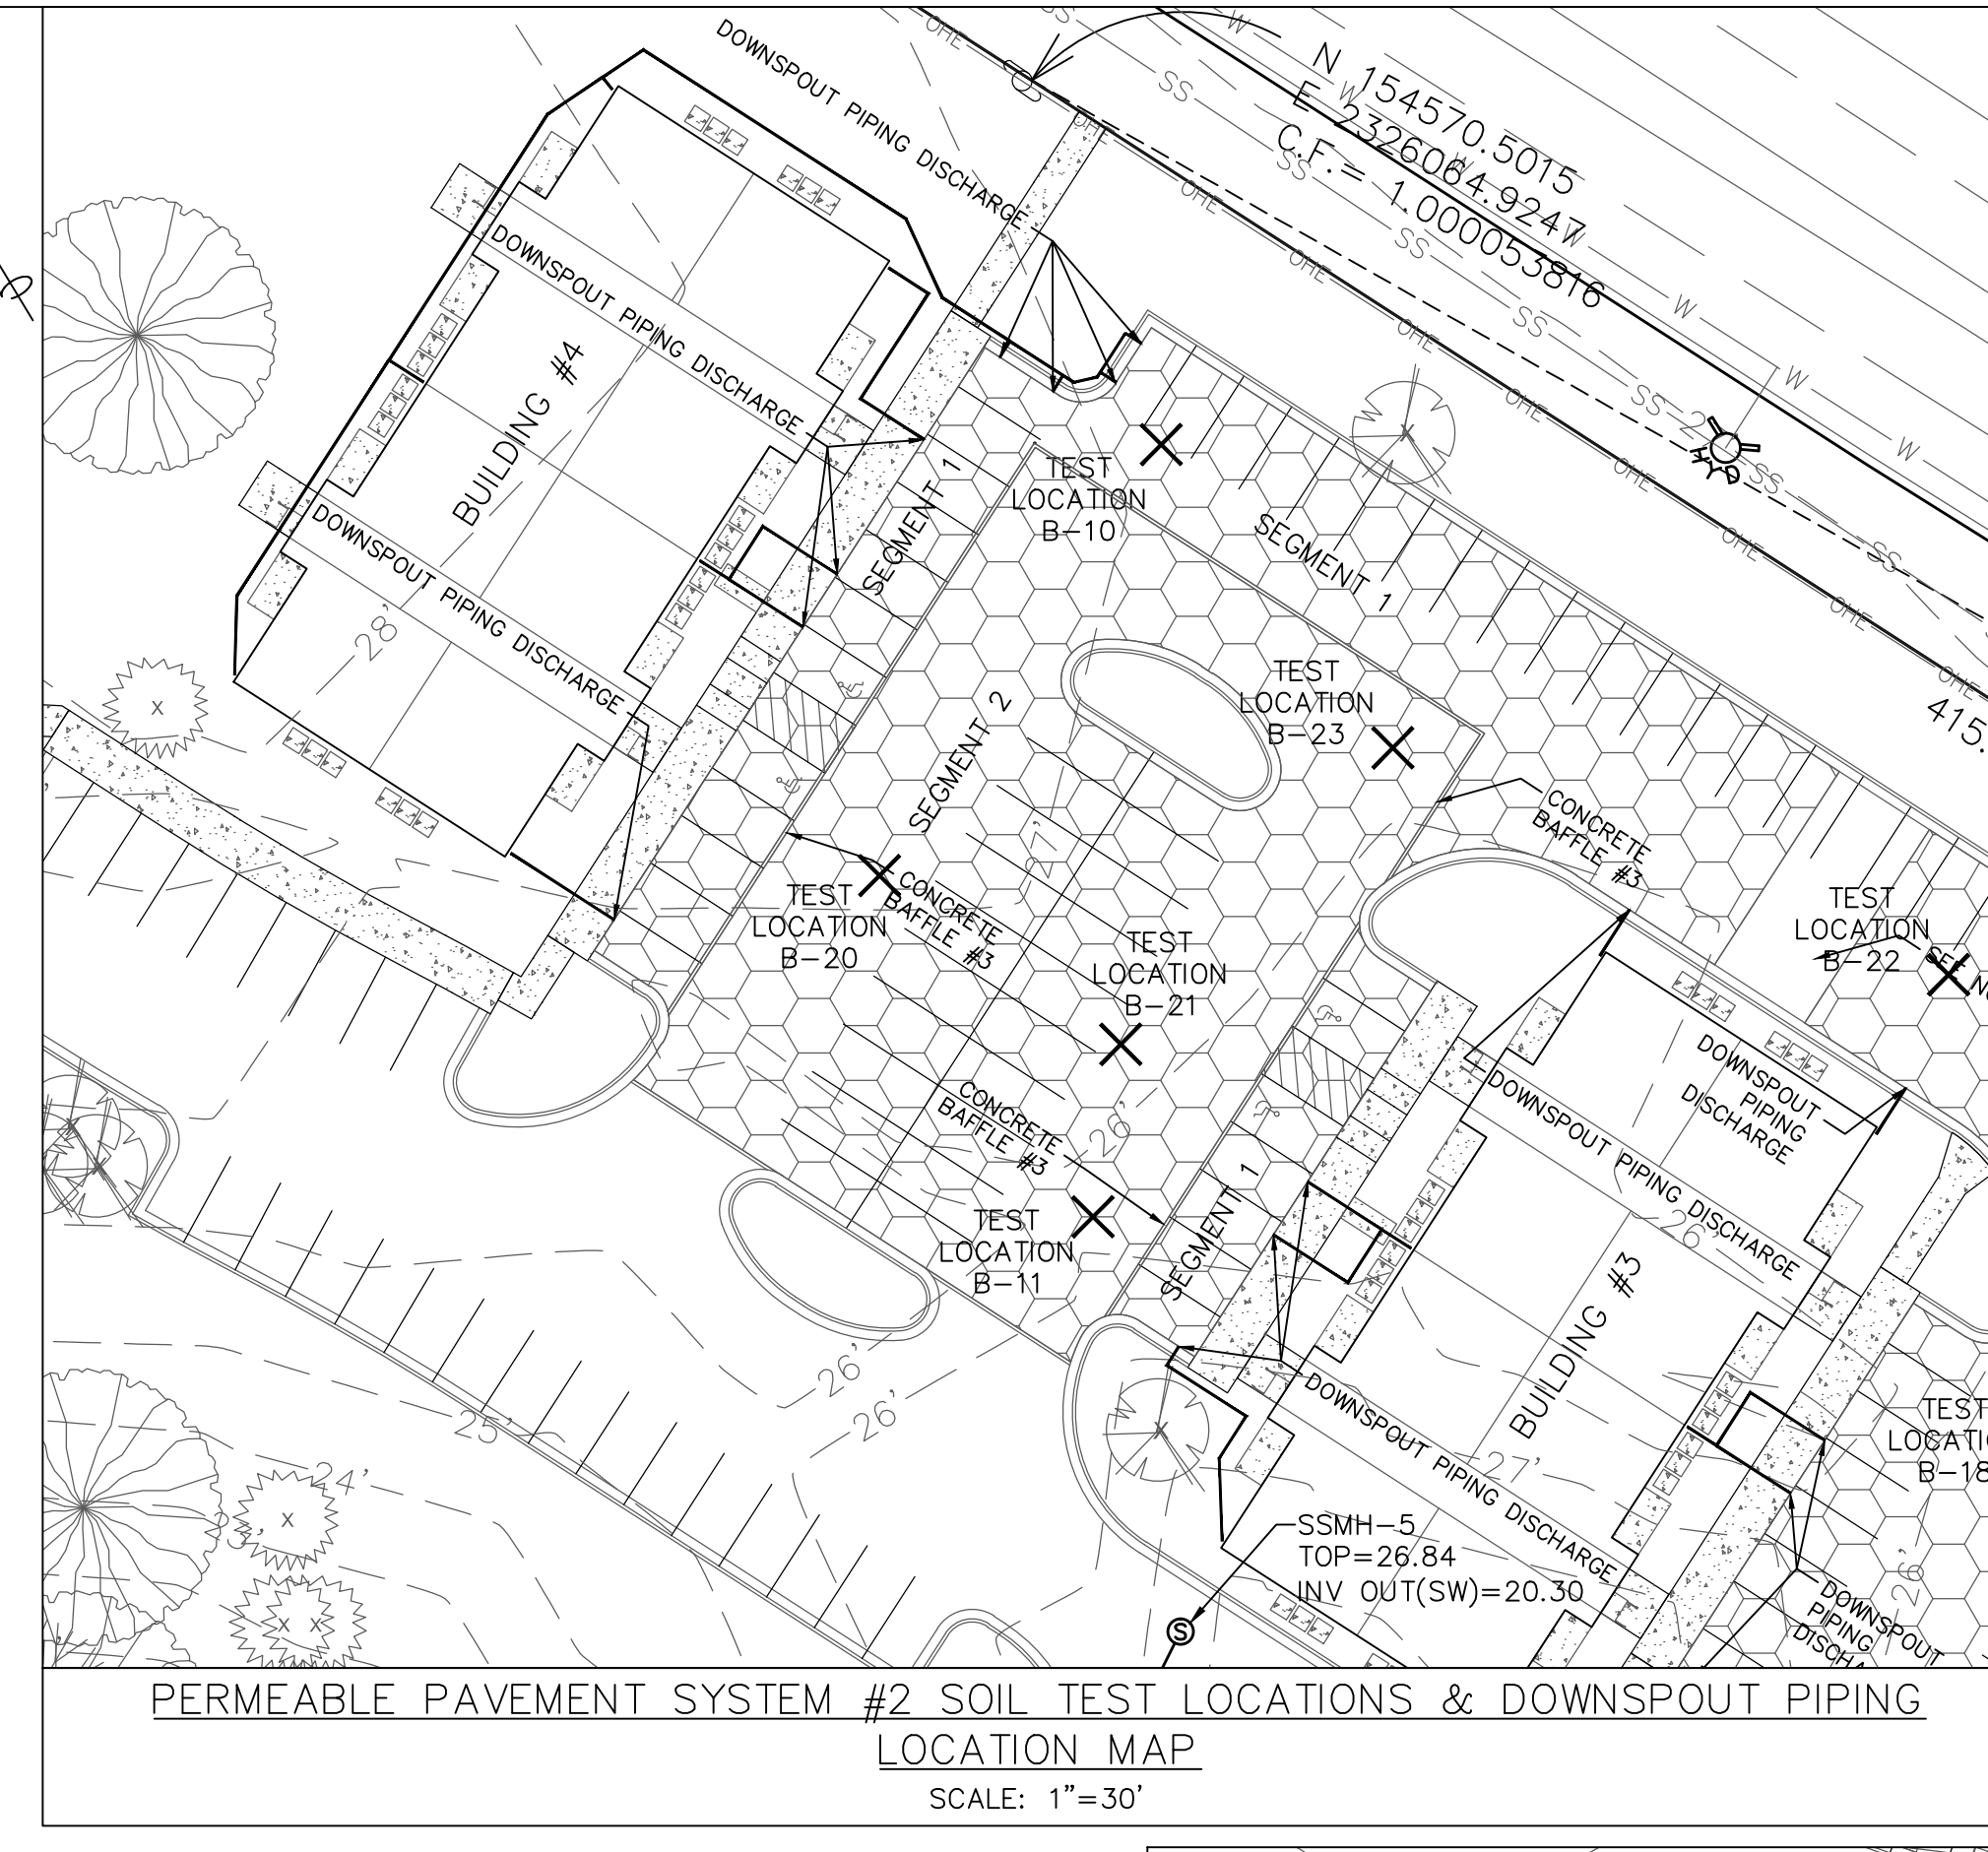
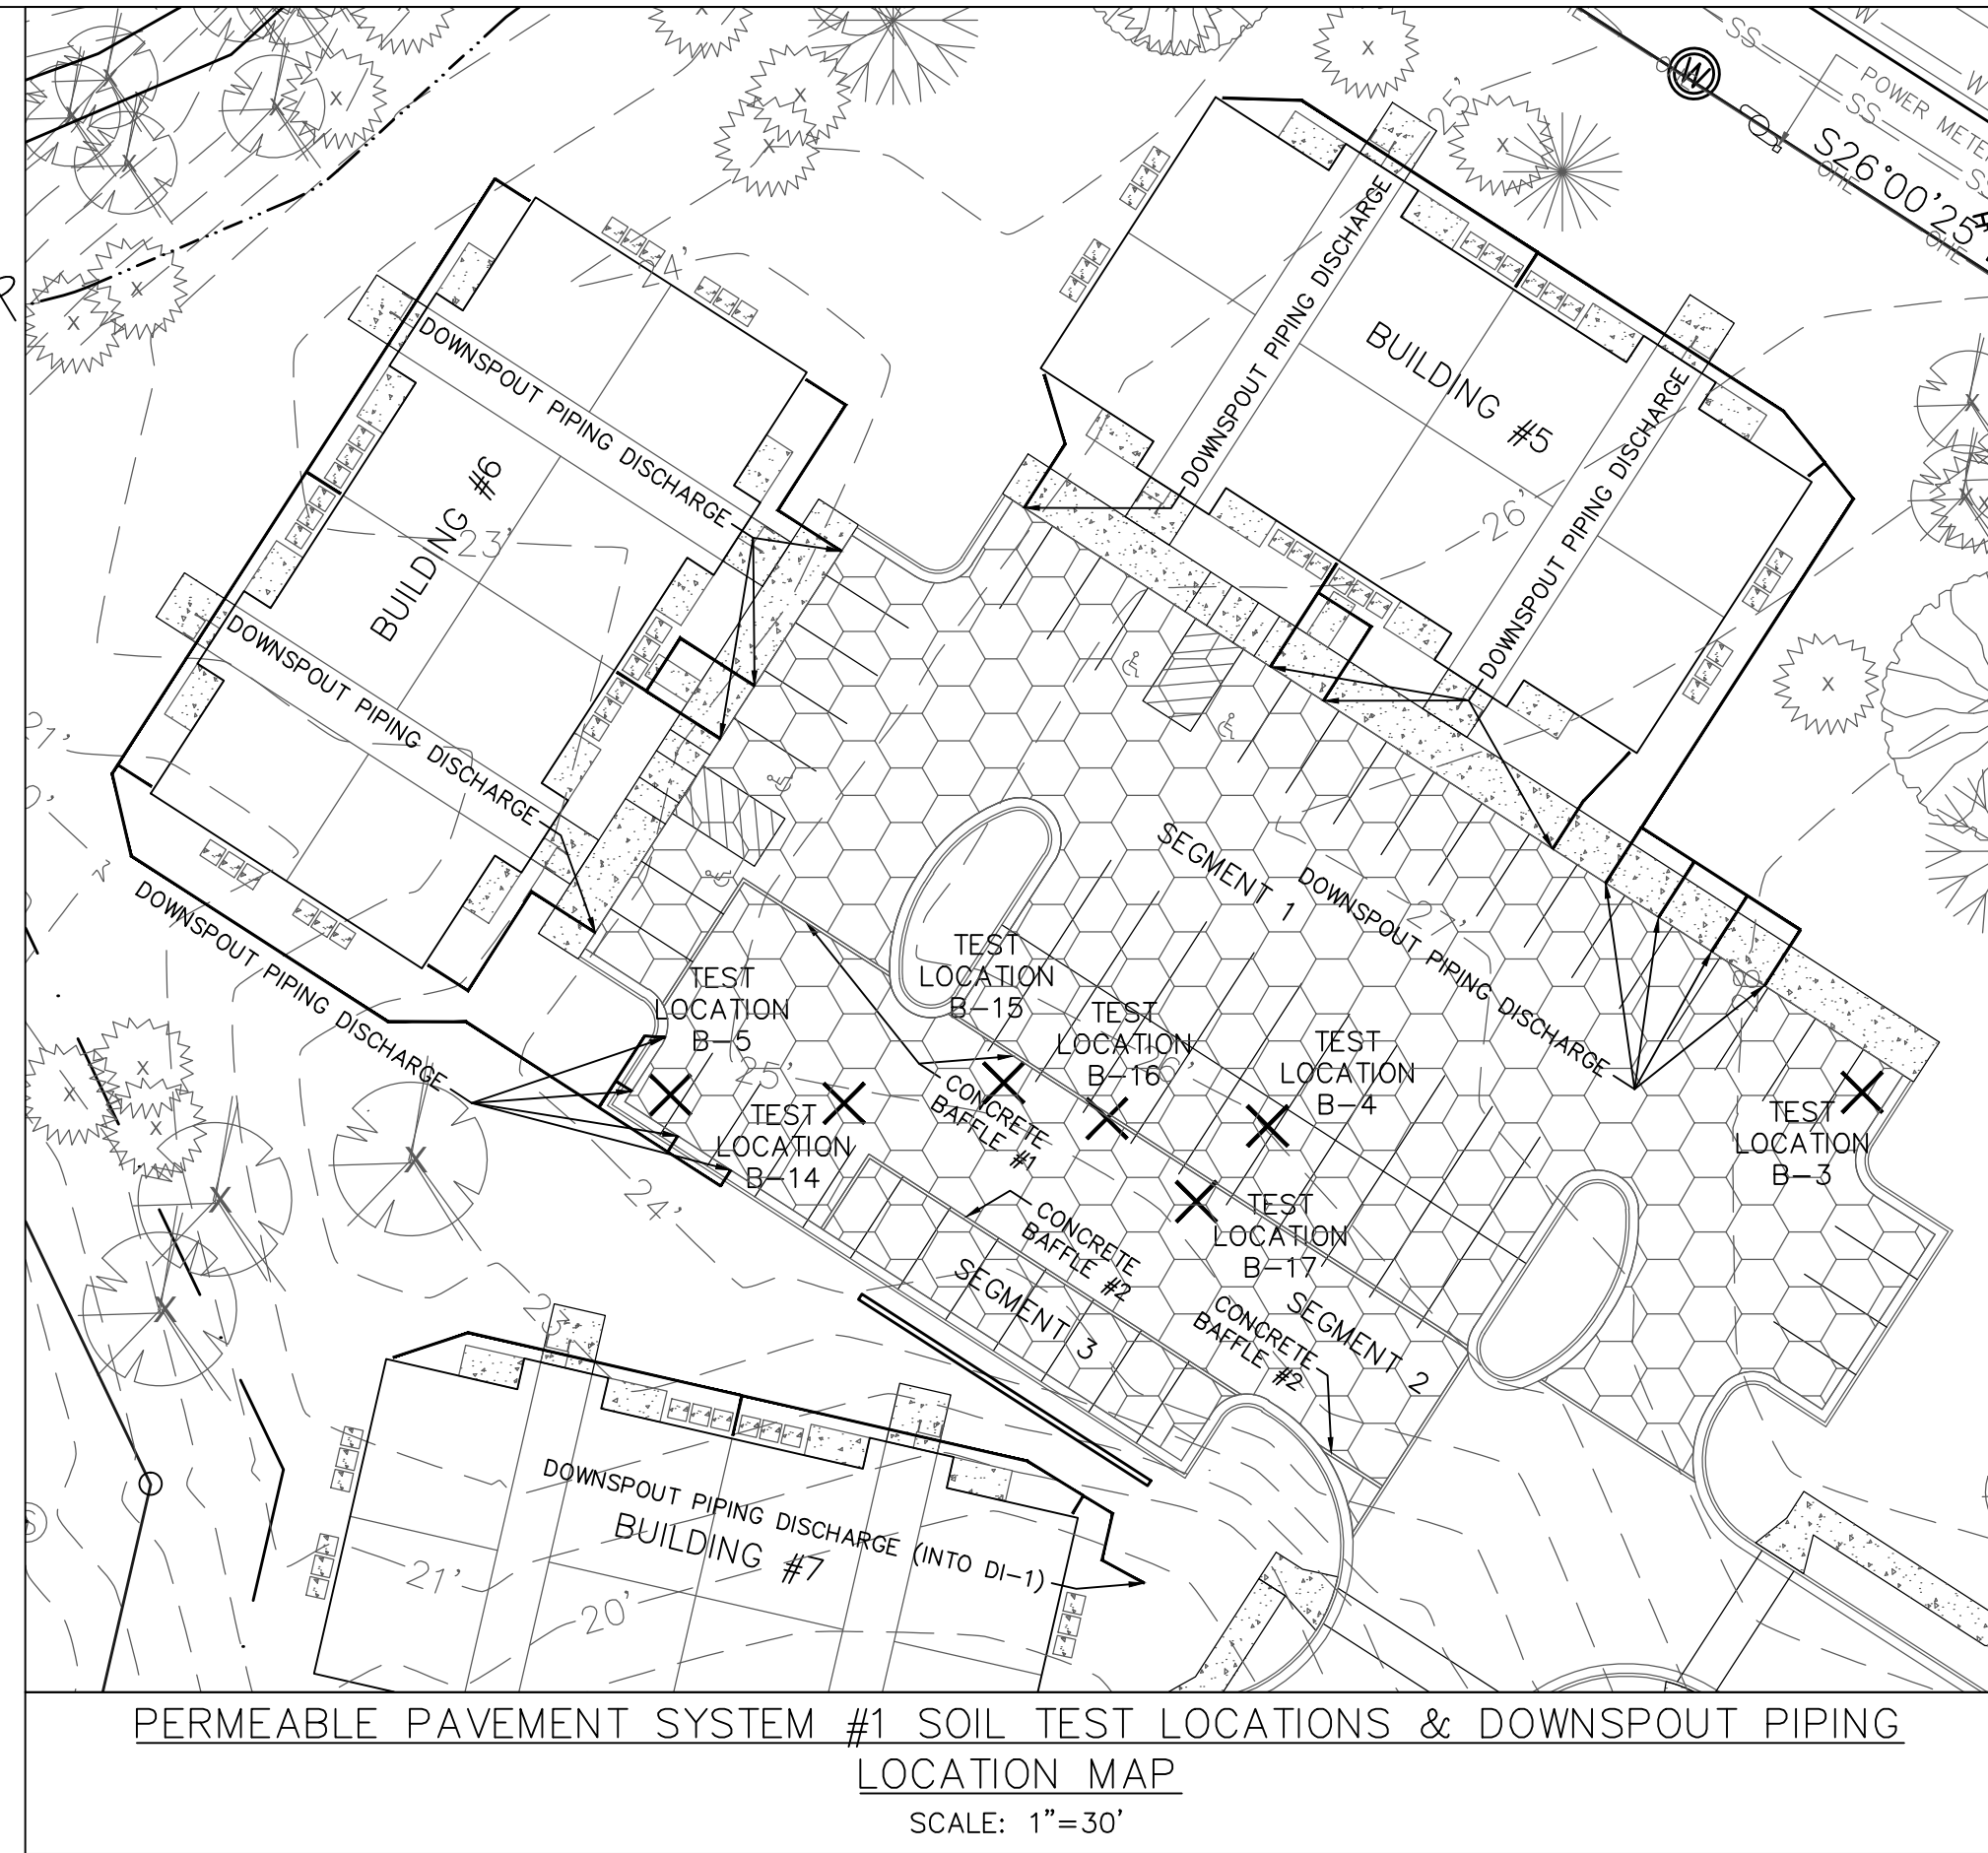
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SHEET NO: 12
OF: 22

REV NO.	DESCRIPTION	DATE
1	REVISED FOR PRELIMINARY BID.	10-16-15
2	REVISED FOR SUBMITTAL.	10-23-15
3	REVISED TO ADD DETAILS.	11-13-15
4	REVISED PER TRC COMMENTS.	12-14-15
5	REVISED PER CITY.	2-9-16

PRELIMINARY PLAN
NOT FOR RECORDATION,
CONVEYANCES, OR SALES

- CONSTRUCTION SEQUENCE FOR INSTALLATION OF PERMEABLE PAVEMENT (NC DENR STORMWATER BMP MANUAL CHAPTER 18)**
- ENSURE ACCEPTABLE CONDITIONS FOR CONSTRUCTION
 - PERVIOUS SURFACES MUST BE GRADED TO DRAIN AWAY FROM THE PERMEABLE PAVEMENT, EXCEPT WHERE THIS IS UNAVOIDABLE, SUCH AS PARKING LOT ISLANDS, AND AREA BETWEEN BUILDINGS & PARKING LOT.
 - IMPERVIOUS AREAS THAT WILL DRAIN TO THE PERMEABLE PAVEMENT ARE COMPLETED.
 - AREAS ADJACENT TO THE PERMEABLE PAVEMENT ARE STABILIZED (VEGETATION, MULCH, STRAW, FIBER BLANKETS, ETC.) IN ORDER TO PREVENT EROSION & POSSIBLE CONTAMINATION WITH SEDIMENTS.
 - CONSTRUCTION ACCESS TO OTHER PORTIONS OF THE SITE IS ESTABLISHED SO THAT NO CONSTRUCTION TRAFFIC PASSES THROUGH THE PERMEABLE PAVEMENT SITE DURING INSTALLATION. INSTALL BARRIERS/FENCES AS NEEDED.
 - WEATHER FORECAST CALLS FOR A WINDOW OF DRY WEATHER TO PREVENT EXCESS COMPACTION OR SMearing OF THE SOIL SUBGRADE WHILE IT IS EXPOSED.
 - EXCAVATE PERMEABLE PAVEMENT AREA & PREPARE SUBGRADE SURFACE
 - EXCAVATE IN DRY SUBGRADE CONDITIONS & AVOID EXCAVATING IMMEDIATELY AFTER STORMS WITHOUT A SUFFICIENT DRYING PERIOD.
 - DO NOT ALLOW EQUIPMENT TO CROSS THE PAVEMENT AREA AFTER EXCAVATION HAS BEGUN.
 - OPERATE EXCAVATION EQUIPMENT FROM OUTSIDE THE EXCAVATION AREA OR FROM UNEXCAVATED PORTIONS OF THE AREA USING AN EXCAVATION STAGING PLAN.
 - USE EQUIPMENT WITH TRACKS RATHER THAN TIRES TO MINIMIZE SOIL COMPACTION WHEN EQUIPMENT ON THE SUBGRADE SURFACE IS UNAVOIDABLE.
 - DIG THE FINAL 9 TO 12 INCHES BY USING THE TEETH OF THE EXCAVATOR BUCKET TO LOOSEN SOIL & DO NOT SMEAR THE SUBGRADE SOIL SURFACE. FINAL GRADING OR SMOOTHING OF SUBGRADE SHOULD BE DONE BY HAND IF POSSIBLE.
 - THE FINAL SUBGRADE SLOPE SHALL NOT EXCEED 0.5%. THE FINAL SUBGRADE SHOULD BE SURVEYED BEFORE PROCEEDING WITH INSTALLATION.
 - MINIMIZE THE TIME BETWEEN EXCAVATION AND PLACEMENT OF THE AGGREGATE.
 - AFTER THE SUBGRADE SLOPE IS VERIFIED, SCARIFY THE SOIL SUBGRADE SURFACE TO MAINTAIN THE SOILS PRE-DISTURBANCE INFILTRATION RATE.
 - TO SCARIFY THE PAVEMENT, USE THE EXCAVATOR BUCKET'S TEETH TO RAKE THE SURFACE OF THE SUBGRADE.
 - TEST THE SUBGRADE SOIL INFILTRATION RATE (INFILTRATION SYSTEMS ONLY)
 - IMMEDIATELY AFTER EXCAVATION & BEFORE THE AGGREGATE IS PLACED, CONDUCT A DIRECT MEASUREMENT OF THE SOIL'S INFILTRATION RATE. INFILTRATION TESTING SHALL BE PERFORMED BY AN APPROPRIATELY-QUALIFIED PROFESSIONAL.
 - RESULTS OF THE INFILTRATION TESTING SHALL BE PROVIDED TO THE ENGINEER.
 - IF THE SOIL TEST SHOWS INFILTRATION RATE(S) THAT ARE LOWER THAN THE RATE(S) USED IN THE DESIGN, THEN ADDITIONAL SCARIFICATION, RIPPING, OR TRENCHING OF THE SOIL WILL BE NEEDED.
 - CONTRACTOR SHALL CONTACT & RECEIVE APPROVAL FROM ENGINEER OF RECORD TO CONTINUE INSTALLATION OF PERMEABLE PAVEMENT.
 - PLACE GEOTEXTILES AND GEOMEMBRANE (IF APPLICABLE)
 - FOLLOW MANUFACTURER'S RECOMMENDATIONS FOR THE APPROPRIATE OVERLAP BETWEEN ROLLS OF MATERIAL. SECURE THE MATERIAL TO EXCAVATION WALLS IF IT DOES NOT MOVE OR WRINKLE WHEN PLACING AGGREGATE.
 - PLACE OBSERVATION WELL(S)
 - PLACE OBSERVATION WELL(S) ACCORDING TO THE PLAN AND VERIFY THAT THE ELEVATIONS ARE CORRECT.
 - PLACE & COMPACT AGGREGATE BASE
 - INSPECT ALL AGGREGATE TO ENSURE THEY ARE CLEAN, FREE OF FINES, AND CONFORM TO THE PLANS.
 - IF AGGREGATE DELIVERED TO THE SITE CANNOT BE IMMEDIATELY PLACED INTO THE EXCAVATION, THEY SHOULD BE STOCKPILED ON AN IMPERVIOUS SURFACE, GEOTEXTILE, OR ON AN IMPERVIOUS MATERIAL TO KEEP THE AGGREGATE FREE OF SEDIMENT.
 - IF AGGREGATE BECOMES CONTAMINATED WITH SEDIMENT, THEN IT SHALL BE REPLACED WITH CLEAN AGGREGATE.
 - BEFORE PLACING THE AGGREGATE, CHECK FOR ANY ACCUMULATION OF SEDIMENTS ON THE FINISHED SOIL SUBGRADE.
 - IF THE EXPOSED SUBGRADE HAS BEEN SUBJECTED TO RAINFALL BEFORE PLACEMENT OF THE AGGREGATE, THEN THE SUBGRADE SURFACE MUST BE SCARIFIED TO BREAK UP THE RESULTING SURFACE CRUST.
 - SLOPES & ELEVATIONS SHALL BE CHECKED ON THE SOIL SUBGRADE AND THE FINISHED ELEVATION OF BASE (AFTER COMPACTION) OR BEDDING MATERIALS TO ASSURE THEY CONFORM TO THE PLANS AND SPECIFICATIONS.
 - THE AGGREGATE SHALL BE SPREAD (NOT DUMPED) BY A FRONT-END LOADER OR FROM DUMP TRUCKS DEPOSITING FROM NEAR THE EDGE OF THE EXCAVATED AREA OR DIRECTLY ON DEPOSITED AGGREGATE PILES. MOISTEN AND SPREAD THE WASHED STONE WITHOUT DRIVING ON THE SUBGRADE. BE CAREFUL NOT TO DAMAGE THE OBSERVATION WELLS DURING COMPACTION.
 - FOLLOW COMPACTION RECOMMENDATIONS BY THE PERMEABLE PAVEMENT MANUFACTURER OR THAT FROM INDUSTRY GUIDELINES.
 - BE SURE THAT CORNERS, AREAS AROUND UTILITY STRUCTURES AND OBSERVATION WELLS, & TRANSITION AREAS TO OTHER PAVEMENTS ARE ADEQUATELY COMPACTED.
 - DO NOT CRUSH AGGREGATES DURING COMPACTION.
 - INSTALL CURB RESTRAINTS AND PAVEMENT BARRIERS
 - EDGE RESTRAINTS AND BARRIERS BETWEEN PERMEABLE IMPERVIOUS PAVEMENT SHALL BE INSTALLED PER THE PLAN. BEFORE MOVING ON TO CONSTRUCTION STEP 8, BE CERTAIN THE DESIGN AND INSTALLATION ARE CONSISTENT.
 - INSTALL PAVEMENT COURSE
 - PERVIOUS CONCRETE SHALL BE CONSTRUCTED IN ACCORDANCE WITH THE LATEST VERSION OF ACI 522.1 SPECIFICATION FOR PERVIOUS CONCRETE.
 - INSTALLATION OF THE PERVIOUS CONCRETE MAY BE ACCOMPLISHED USING EITHER THE ONE-STEP OR THE TWO-STEP METHOD.
 - PROTECT THE PAVEMENT THROUGH PROJECT COMPLETION
 - IF IT IS NOT POSSIBLE TO INSTALL THE PERMEABLE PAVEMENT AT THE END OF THE SITE CONSTRUCTION TIMELINE, THEN PROTECT THE PAVEMENT UNTIL PROJECT COMPLETION. THIS SHALL BE DONE BY:
 - ROUTING CONSTRUCTION ACCESS THROUGH OTHER PORTIONS OF THE SITE SO THAT NO CONSTRUCTION TRAFFIC PASSES THROUGH THE PERMEABLE PAVEMENT SITE (INSTALL BARRIERS/FENCES AS NEEDED).
 - IF THIS IS NOT POSSIBLE, PROTECT THE PAVEMENT PER THE CONSTRUCTION DOCUMENTS. PROTECTION TECHNIQUES THAT MAY BE USED INCLUDE MATS, PLASTIC SHEETING, BARRIERS TO LIMIT ACCESS, OR MOVING THE STABILIZED CONSTRUCTION ENTRANCE.
 - SCHEDULE STREET SWEEPING DURING AND AFTER CONSTRUCTION TO PREVENT SEDIMENT FROM ACCUMULATING ON THE PAVEMENT.



REV NO.	DESCRIPTION	DATE
1	REVISED FOR PRELIMINARY BID.	10-16-15
2	REVISED FOR SUBMITTAL.	10-23-15
3	REVISED TO ADD DETAILS.	11-16-15
4	REVISED TO ADD DETAILS.	11-24-15
5	REVISED TO ADD DETAILS.	12-14-15
6	REVISED PER CITY.	2-9-16

Approved Construction Plan

Name: _____ Date: _____

Planning _____

Traffic _____

Fire _____

City of Wilmington
Public Services • Engineering Division
APPROVED STORMWATER MANAGEMENT PLAN

Date: _____ Permit # _____

Signed: _____

STORMWATER DETAIL SHEET
4010 CAROLINA BEACH ROAD
ECHO FARM APARTMENTS
WILMINGTON TOWNSHIP NEW HANOVER COUNTY NORTH CAROLINA

DATE: 10-1-15
SCALE: VARIES
DRAWN: JCB
CHECKED: JEM
PROJECT NO: 260

FINAL DRAWING FOR REVIEW PURPOSES ONLY

MALPASS ENGINEERING & SURVEYING, P.C.
1134 SHIPYARD BOULEVARD
WILMINGTON, NORTH CAROLINA 28412
Phone 910-392-6243 Fax 910-392-6203 License No. C-2320

Developer: ECHO FARM APARTMENTS, LLC
10 CAROLINA DRIVE
WILMINGTON, NORTH CAROLINA 28403
PHONE: 910-251-5030

SHEET NO: 13
OF: 22



INLET DRAINAGE AREA CHART	
INLET	DRAINAGE AREA (ACRES)
CB-1	0.20
CB-2	0.18
CB-3	0.42
CB-4	0.77
CB-5	0.34
CB-6	0.23
CB-7	0.19
CB-8	0.24
DI-1	0.13
DI-2	0.66
DI-3	0.01
DI-4 & SWALE #3	0.16
*DI-5 & SWALE #4	0.36
DI-6 & SWALE #5	0.91
DI-7	0.23
SWALE #1	1.21
**SWALE #2	1.71
SWALE #6	0.119

*DI-5 D.A. INCLUDES DI-4 D.A.
**SWALE #2 D.A. INCLUDES SWALE #1 D.A.

Pipe Table - System #1						
From	To	Size	Length	Slope	D.S. Invert	U.S. Invert
CB-8	Pond	15	78	1.78%	8.50	9.87
CB-7	CB-8	15	103	4.05%	9.87	14.01
SDMH-6	CB-7	15	81	1.19%	14.01	15.00

Pipe Table - System #2						
From	To	Size	Length	Slope	D.S. Invert	U.S. Invert
CB-4	Pond	24	78	0.29%	9.00	9.23
SDMH-3	CB-4	24	92	0.78%	9.23	9.96
SDMH-2	SDMH-3	18	62	0.91%	9.96	10.55
SDMH-1	SDMH-2	18	34	0.68%	10.55	10.80
DI-2	SDMH-1	18	125	0.31%	10.80	11.19
DI-7	SDMH-3	15	85	0.50%	11.26	11.69
DI-6	DI-7	12	57	0.50%	11.69	11.98
CB-3	SDMH-2	15	16	11.95%	10.55	12.58
DI-1	SDMH-1	15	154	3.51%	10.80	16.28
DI-3	DI-1	15	20	4.25%	16.28	17.23
CB-1	DI-3	15	104	3.46%	17.23	20.87

Pipe Table - System #3						
From	To	Size	Length	Slope	D.S. Invert	U.S. Invert
CB-6	Pond	18	69	0.31%	15.00	15.21
SDMH-5	CB-6	15	81	6.43%	15.21	20.60
SDMH-4	SDMH-5	15	46	0.51%	20.60	20.85
CB-5	SDMH-4	15	44	0.50%	20.85	21.08

Pipe Table - System #4						
From	To	Size	Length	Slope	D.S. Invert	U.S. Invert
CB-2	Pond	15	46	0.23%	10.50	10.61
DI-5	CB-2	15	50	2.62%	10.61	11.98


Pipe Table - System #5						
From	To	Size	Length	Slope	D.S. Invert	U.S. Invert
DI-4	Swale	12	13	0.36%	22.48	22.53

Pipe Table - Driveway Culvert						
From	To	Size (in)	Length (ft)	Slope (%)	D.S. Invert (ft)	U.S. Invert (ft)
Upstream	Downstream	15 (Class IV)	96	1.43	11.87	13.24

Pipe Table - Wet Pond #1 Outfall						
From	To	Size (in)	Length (ft)	Slope (%)	D.S. Invert (ft)	U.S. Invert (ft)
Pond	Downstream	18	92	0.60	9.30	9.85

Pipe Table - Culvert Downstream of Swale #7						
From	To	Size (in)	Length (ft)	Slope (%)	D.S. Invert (ft)	U.S. Invert (ft)
Swale #7	Downstream	15	21	2.20	22.70	23.16

DRAINAGE AREA MAP-INLETS
SCALE: 1"=40'

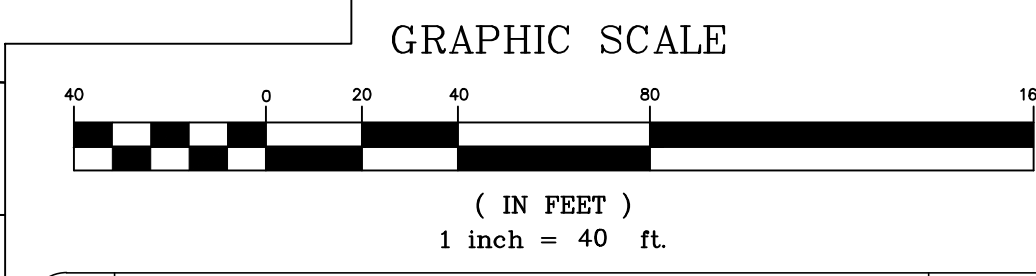

REV NO.	DESCRIPTION	DATE
1	REVISED TO ADD SWALE #7 DRAINAGE AREA & PIPE CHART.	12-14-15
2	REVISED PER CITY.	2-9-16

APPROVED CONSTRUCTION PLAN

Name: _____ Date: _____

Planning: _____

Traffic: _____

Fire: _____

Public Services • Engineering Division

APPROVED STORMWATER MANAGEMENT PLAN

Date: _____ Permit # _____

Signed: _____

DRAINAGE AREA MAP
4010 CAROLINA BEACH ROAD
ECHO FARM APARTMENTS
WILMINGTON TOWNSHIP NEW HANOVER COUNTY NORTH CAROLINA

MALPASS ENGINEERING & SURVEYING, P.C.
1134 SHIPYARD BOULEVARD
WILMINGTON, NORTH CAROLINA 28412
Phone 910-392-5243 License No. C-2320
Fax 910-392-5203

Developer: ECHO FARM APARTMENTS, LLC
10 S. CARDINAL DRIVE
WILMINGTON, NORTH CAROLINA 28403
PHONE: 910-251-5030

DATE: 11-24-15
SCALE: 1"=40'
DRAWN: JCB
CHECKED: JEM
PROJECT NO: 260
SHEET NO: 14
OF: 22

PRELIMINARY PLAT
NOT FOR RECORDATION,
CONVEYANCES, OR SALES

STANDARD DETAIL
GUIDELINES FOR STORM DRAIN MANHOLE

DATE: 2001
DRAWN BY: JSR/CMR
CHECKED BY: B.P., P.E.
SCALE: NOT TO SCALE

SECTION "A-A"
FINISH AS GRADED
STD. CITY OF WILMINGTON M.H. COVER, SEE DETAIL SHEET SD-14-01 & 14-02
3/4" CEMENT PLASTER
MAX. CORBEL 1" PER COURSE
STEPS
1'-0"
7.5"
4'-0"
VARIES - SEE PLAN / PROFILE

WILMINGTON NORTH CAROLINA
CITY OF WILMINGTON ENGINEERING
PO BOX 1810
WILMINGTON, NC 28402
(910) 341-7807
SD 2-03

STANDARD DETAIL
GRILL BASIN

DATE: 2001
DRAWN BY: JSR
CHECKED BY: B.P., P.E.
SCALE: NOT TO SCALE

SECTION "A-A"
4"
2'-0" MIN.
3/4" CEMENT PLASTER TYP. ALL SIDES
STEPS
4'-0"
VARIES
INLET PIPE
OUTLET PIPE
PLAN

WILMINGTON NORTH CAROLINA
CITY OF WILMINGTON ENGINEERING
PO BOX 1810
WILMINGTON, NC 28402
(910) 341-7807
SD 2-02

STANDARD DETAIL
GRILL BASIN

DATE: 2001
DRAWN BY: JSR
CHECKED BY: B.P., P.E.
SCALE: NOT TO SCALE

SECTION "A-A"
4"
2'-0" MIN.
3/4" CEMENT PLASTER TYP. ALL SIDES
STEPS
4'-0"
VARIES
INLET PIPE
OUTLET PIPE
PLAN

NOTE: SEE NOTES #22 & 23 ON SHEET 1.
CLASS "A" CONC.

WILMINGTON NORTH CAROLINA
CITY OF WILMINGTON ENGINEERING
PO BOX 1810
WILMINGTON, NC 28402
(910) 341-7807
SD 2-02

STANDARD DETAIL
CATCH BASIN CASTING FOR 30" HOOD AND GRATE

DATE: 2001
DRAWN BY: JSR/CMR
CHECKED BY: B.P., P.E.
SCALE: NOT TO SCALE

43"
36"
28.87"
SECTION - LL
SECTION - MM
SECTION - BB
SECTION - AA
SECTION - NN
SECTION - RR
SECTION - JJ
SECTION - KK

WILMINGTON NORTH CAROLINA
CITY OF WILMINGTON ENGINEERING
PO BOX 1810
WILMINGTON, NC 28402
(910) 341-7807
SD 2-19

STANDARD DETAIL
CATCH BASIN GRATE FOR 30" HOOD AND GRATE

DATE: 2001
DRAWN BY: JSR/CMR
CHECKED BY: B.P., P.E.
SCALE: NOT TO SCALE

36"
28.87"
SECTION - AA
SECTION - BB
SECTION - CC
SECTION - DD
SECTION - EE
SECTION - FF
SECTION - GG
SECTION - HH
SECTION - II
SECTION - JJ
SECTION - KK
SECTION - LL
SECTION - MM
SECTION - NN
SECTION - OO
SECTION - PP
SECTION - QQ
SECTION - RR
SECTION - SS
SECTION - TT
SECTION - UU
SECTION - VV
SECTION - WW
SECTION - XX
SECTION - YY
SECTION - ZZ

WILMINGTON NORTH CAROLINA
CITY OF WILMINGTON ENGINEERING
PO BOX 1810
WILMINGTON, NC 28402
(910) 341-7807
SD 2-20

STANDARD DETAIL
TYPICAL STORM WATER FACILITY LANDSCAPING PLAN

DATE: JULY 2003
DRAWN BY: JSR
CHECKED BY: B.P., P.E.
SCALE: NOT TO SCALE

CANOPY TREE FOR A FOCAL POINT
WEeping Willow, LIVE OAK
CLUSTER SHRUBS FOR LOW MAINTENANCE
MAINTENANCE EQUIPMENT ACCESSIBILITY
SEED OR SOD SIDESLOPES
LANDSCAPE STRIP VARIES ACCORDING TO SIZE OF POND
SEE PART D & G OF CHAPTER VI
VEGETATION MUST BE EVENLY DISTRIBUTED AT APPROXIMATELY 100' INTERVALS AROUND POND

Notes:
1. If possible, locate pond where vegetation exists.
2. Suggest minimal clearing to conserve visual quality of site and minimize the additional of tree planting. An irregular shape provides a more natural appearance.
3. Landscape strip shall be a maximum slope of 7:1 in order to plant vegetation.
4. Provide a minimum of 3 inches of mulch around all vegetation.

WILMINGTON NORTH CAROLINA
CITY OF WILMINGTON ENGINEERING
PO BOX 1810
WILMINGTON, NC 28402
(910) 341-7807
SD 2-15

STANDARD DETAIL
STANDARD MAN-HOLE RING AND COVER

DATE: 2001
DRAWN BY: JSR/CMR
CHECKED BY: B.P., P.E.
SCALE: NOT TO SCALE

2'-1"
1'-11 3/4"
1'-11 1/2"
7.5"
4.125"
1'-8 3/8"
1'-9 5/8"
1'-10 1/4"
2'-9 1/4"
5.5"
0.5"
MINIMUM WEIGHTS:
RING 261 LBS.
COVER 120 LBS.

NOTE:
RING & COVER CONTACT SURFACES SHALL BE MACHINED TO INSURE EVEN BEARING OF COVER AND RING

WILMINGTON NORTH CAROLINA
CITY OF WILMINGTON ENGINEERING
PO BOX 1810
WILMINGTON, NC 28402
(910) 341-7807
SD 14-02

STANDARD DETAIL
SLIP RESISTANT MANHOLE STEP

DATE: 2001
DRAWN BY: JSR/CMR
CHECKED BY: B.P., P.E.
SCALE: NOT TO SCALE

12"
4"
5"
#3 OR #4 REBAR
SLIP RESISTANT CLEATS
CORROSION RESISTANT MATERIAL (RUBBER, PLASTIC)

WILMINGTON NORTH CAROLINA
CITY OF WILMINGTON ENGINEERING
PO BOX 1810
WILMINGTON, NC 28402
(910) 341-7807
SD 14-10

STANDARD DETAIL
SLIP RESISTANT MANHOLE STEP

DATE: 2001
DRAWN BY: JSR/CMR
CHECKED BY: B.P., P.E.
SCALE: NOT TO SCALE

12"
4"
5"
#3 OR #4 REBAR
SLIP RESISTANT CLEATS
CORROSION RESISTANT MATERIAL (RUBBER, PLASTIC)

WILMINGTON NORTH CAROLINA
CITY OF WILMINGTON ENGINEERING
PO BOX 1810
WILMINGTON, NC 28402
(910) 341-7807
SD 14-10

DRIVEWAYS & TRAFFIC SIGNALS WITHIN 500' OF SOUTHEAST CORNER OF SITE
SCALE: 1"=40'

SOUTHEAST CORNER OF SITE

NOTE: DRIVEWAYS, POLES (EXCEPT ALONG SITE FRONTAGE), & MARKINGS TRACED/APPROXIMATED BASED ON NHC GIS 2010 AERIAL, GOOGLE AERIAL, & GOOGLE STREET VIEW.

DRIVEWAYS & TRAFFIC SIGNALS WITHIN 500' OF NORTHEAST CORNER OF SITE
SCALE: 1"=40'

NORTHEAST CORNER OF SITE

NOTE: DRIVEWAYS, POLES (EXCEPT ALONG SITE FRONTAGE), & MARKINGS TRACED/APPROXIMATED BASED ON NHC GIS 2010 AERIAL, GOOGLE AERIAL, & GOOGLE STREET VIEW.

DRIVEWAYS ON ADJACENT PROPERTY
SCALE: 1"=40'

SOUTHWEST CORNER OF SITE

NOTE: DRIVEWAYS TRACED/APPROXIMATED BASED ON NHC GIS 2010 AERIAL, GOOGLE AERIAL, & GOOGLE STREET VIEW.

DRIVEWAYS WITHIN 250' OF NORTHWEST CORNER OF SITE
SCALE: 1"=40'

NORTHWEST CORNER OF SITE

NOTE: DRIVEWAYS TRACED/APPROXIMATED BASED ON NHC GIS 2010 AERIAL, GOOGLE AERIAL, & GOOGLE STREET VIEW.

STANDARD DETAIL
STANDARD MAN-HOLE RING AND COVER

DATE: 2001
DRAWN BY: JSR/CMR
CHECKED BY: B.P., P.E.
SCALE: NOT TO SCALE

2'-1"
1'-11 3/4"
1'-11 1/2"
7.5"
4.125"
1'-8 3/8"
1'-9 5/8"
1'-10 1/4"
2'-9 1/4"
5.5"
0.5"
MINIMUM WEIGHTS:
RING 261 LBS.
COVER 120 LBS.

WILMINGTON NORTH CAROLINA
CITY OF WILMINGTON ENGINEERING
PO BOX 1810
WILMINGTON, NC 28402
(910) 341-7807
SD 14-02

STANDARD DETAIL
SLIP RESISTANT MANHOLE STEP

DATE: 2001
DRAWN BY: JSR/CMR
CHECKED BY: B.P., P.E.
SCALE: NOT TO SCALE

12"
4"
5"
#3 OR #4 REBAR
SLIP RESISTANT CLEATS
CORROSION RESISTANT MATERIAL (RUBBER, PLASTIC)

WILMINGTON NORTH CAROLINA
CITY OF WILMINGTON ENGINEERING
PO BOX 1810
WILMINGTON, NC 28402
(910) 341-7807
SD 14-10

STANDARD DETAIL
SLIP RESISTANT MANHOLE STEP

DATE: 2001
DRAWN BY: JSR/CMR
CHECKED BY: B.P., P.E.
SCALE: NOT TO SCALE

12"
4"
5"
#3 OR #4 REBAR
SLIP RESISTANT CLEATS
CORROSION RESISTANT MATERIAL (RUBBER, PLASTIC)

WILMINGTON NORTH CAROLINA
CITY OF WILMINGTON ENGINEERING
PO BOX 1810
WILMINGTON, NC 28402
(910) 341-7807
SD 14-10

Approved Construction Plan

Name: _____ Date: _____

Planning: _____
Traffic: _____
Fire: _____

APPROVED STORMWATER MANAGEMENT PLAN
Date: _____ Permit # _____
Signed: _____

DETAIL SHEET
4010 CAROLINA BEACH ROAD
ECHO FARM APARTMENTS
WILMINGTON TOWNSHIP NEW HANOVER COUNTY NORTH CAROLINA















MALPASS ENGINEERING & SURVEYING, P.C.
1134 SHIPYARD BOULEVARD
WILMINGTON, NORTH CAROLINA 28412
Phone 910-392-5243
Fax 910-392-5203 License No. C-2320

Developer: ECHO FARM APARTMENTS, LLC
10 S. CARDINAL DRIVE
WILMINGTON, NORTH CAROLINA 28403
PHONE: 910-251-5030

DATE: 11-24-15
SCALE: N.T.S.
DRAWN: JCB
CHECKED: JEM
PROJECT NO: 260
SHEET NO: 15
OF: 22

FINAL DRAWING FOR REVIEW PURPOSES ONLY

REV. NO. DESCRIPTION DATE

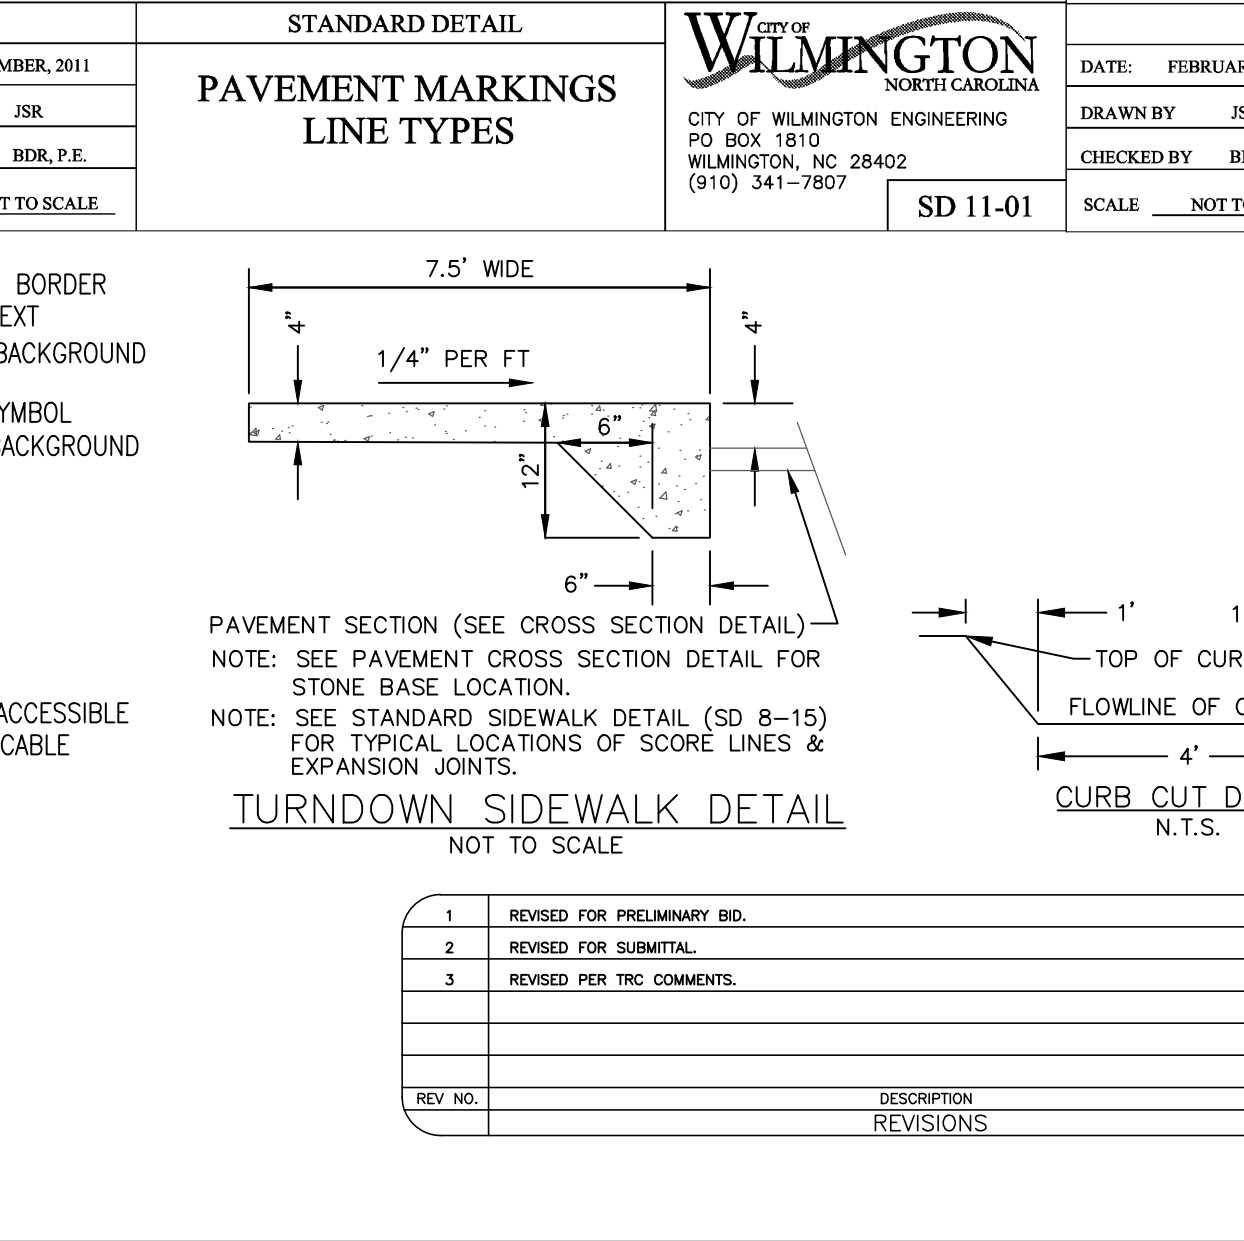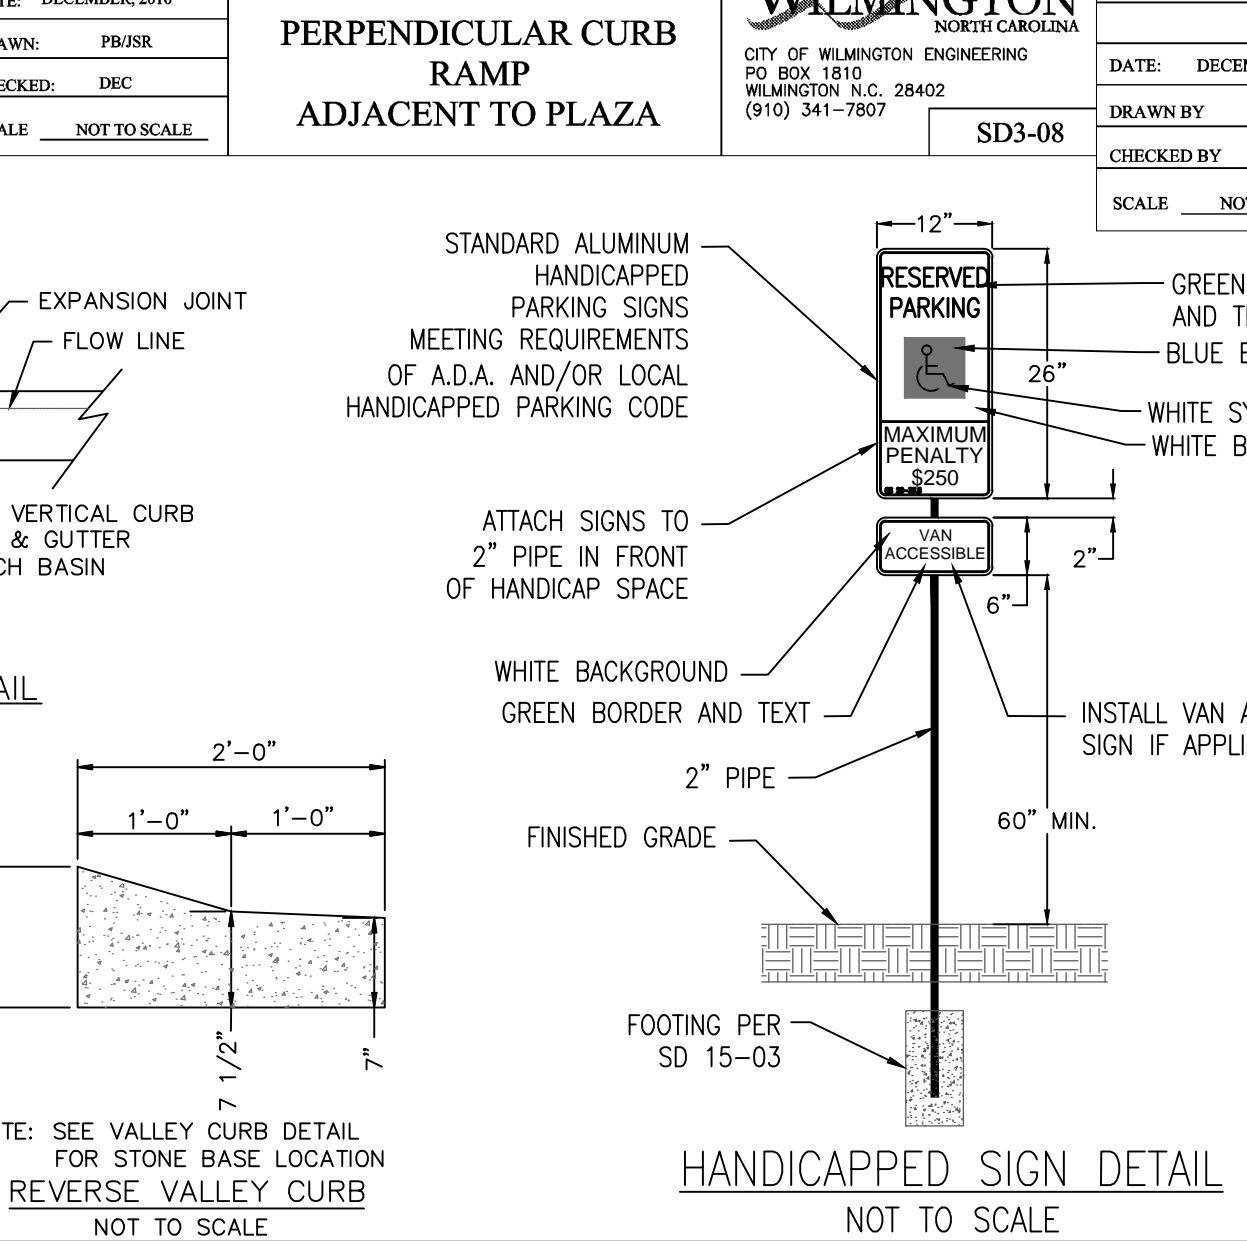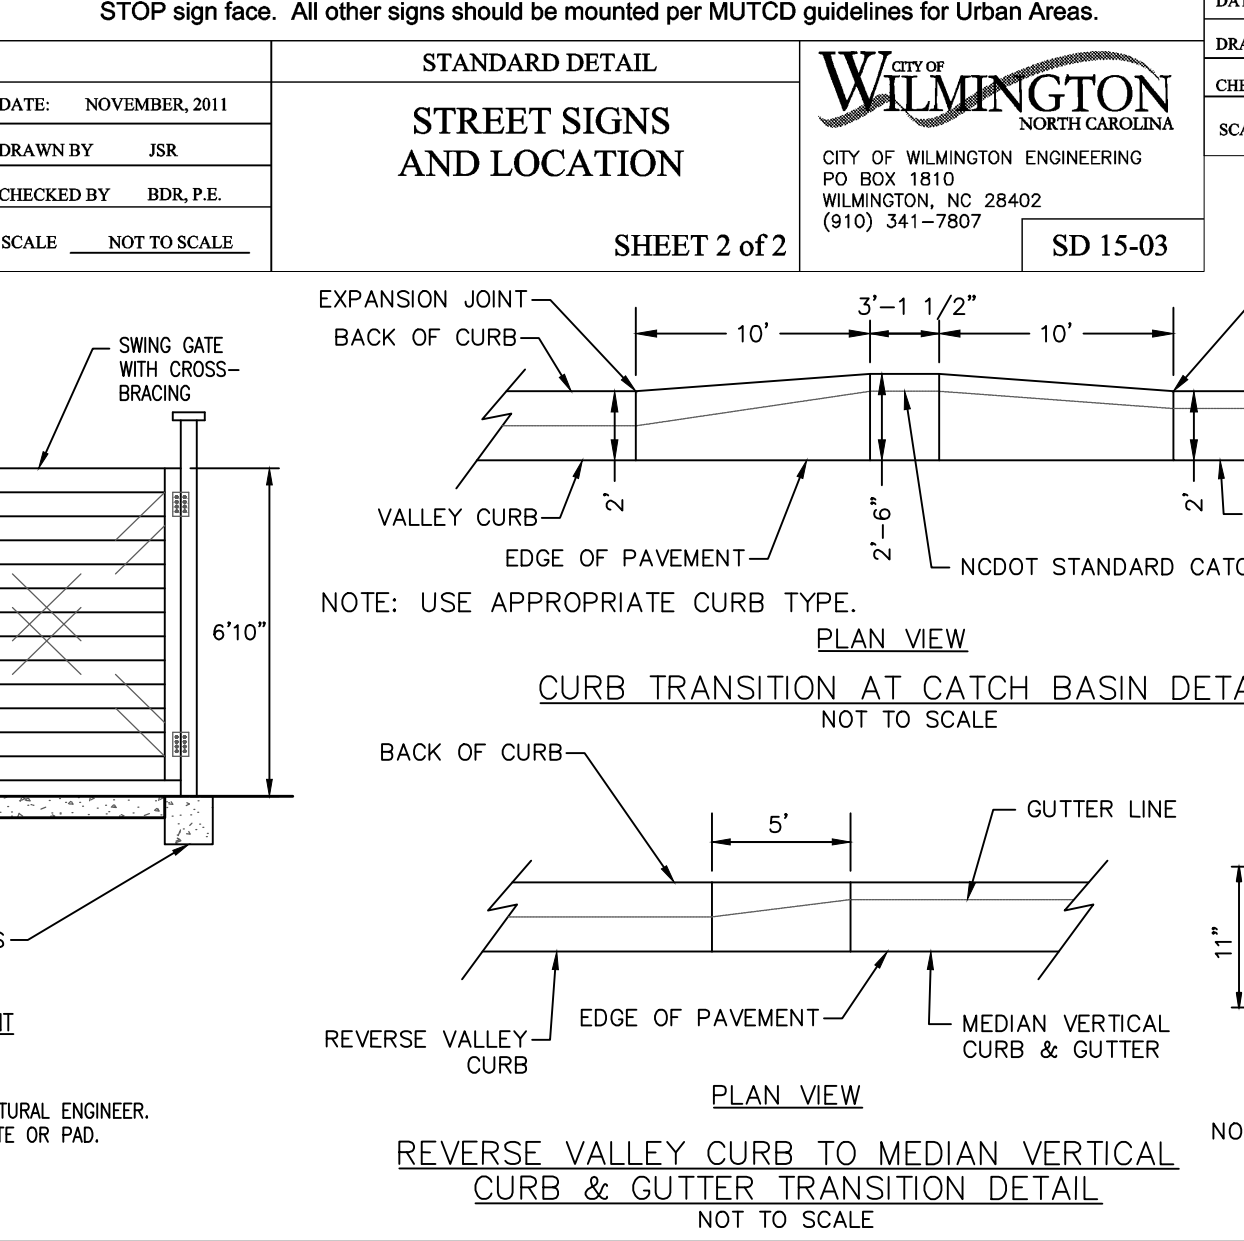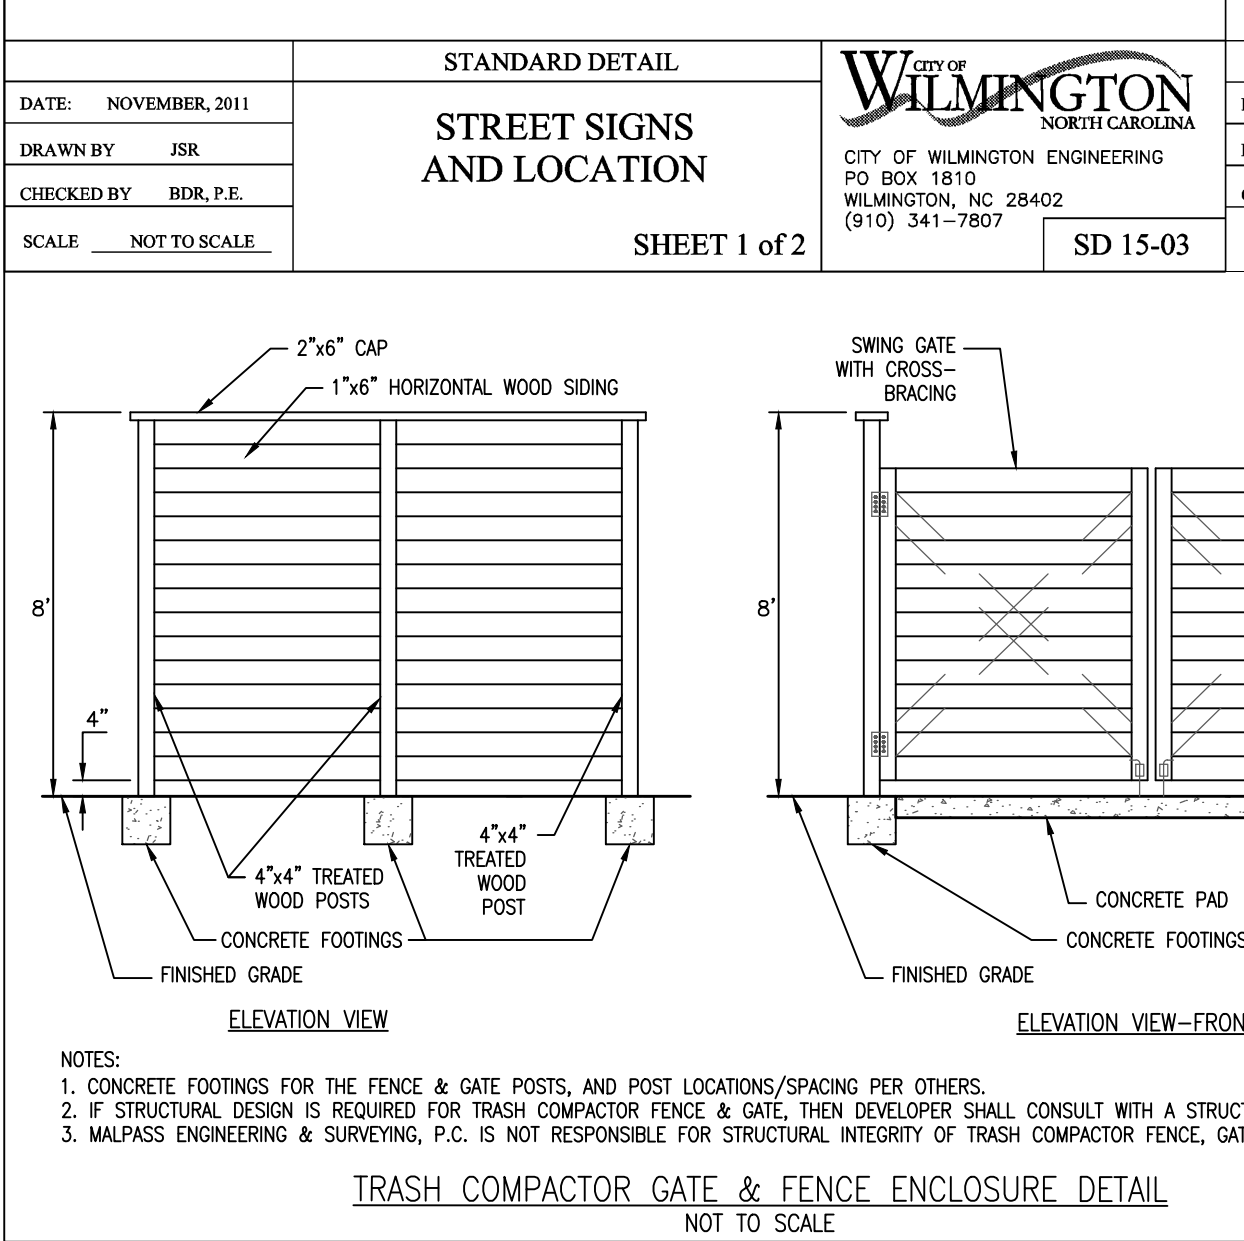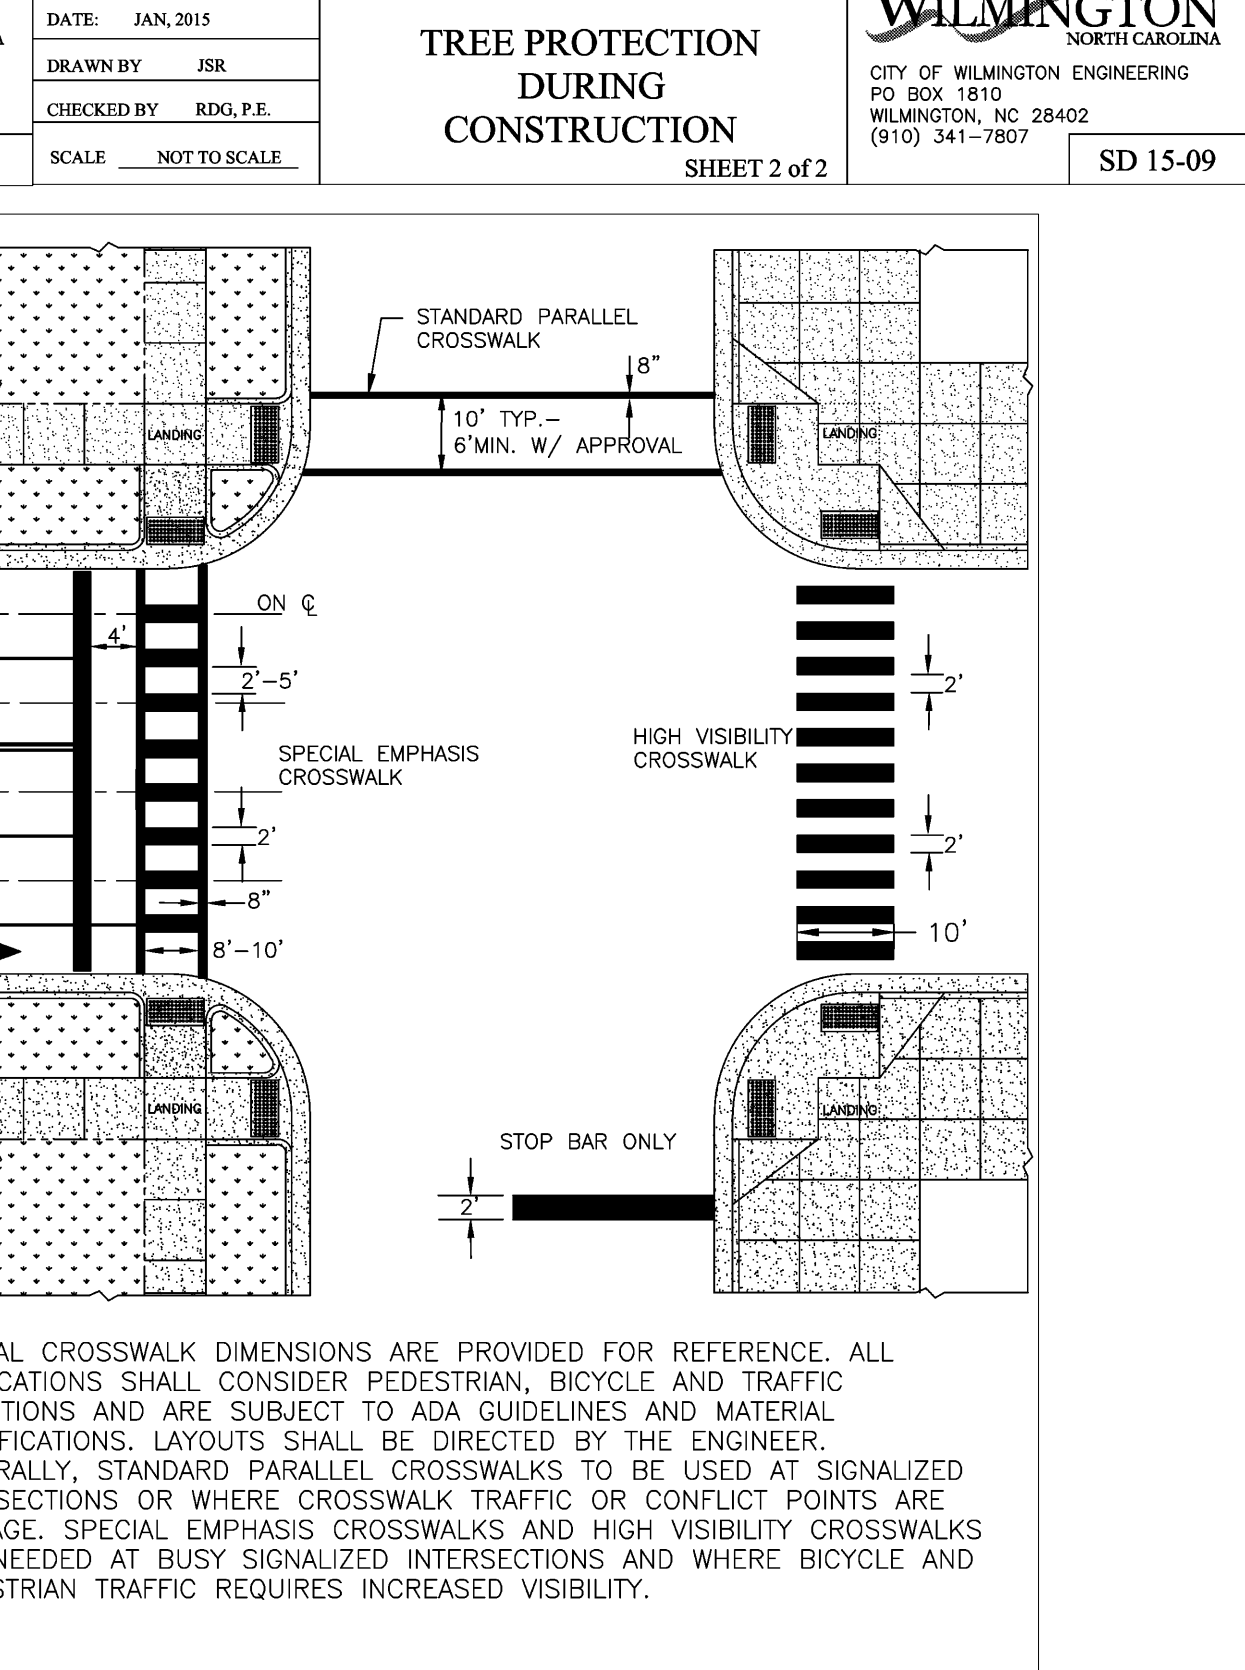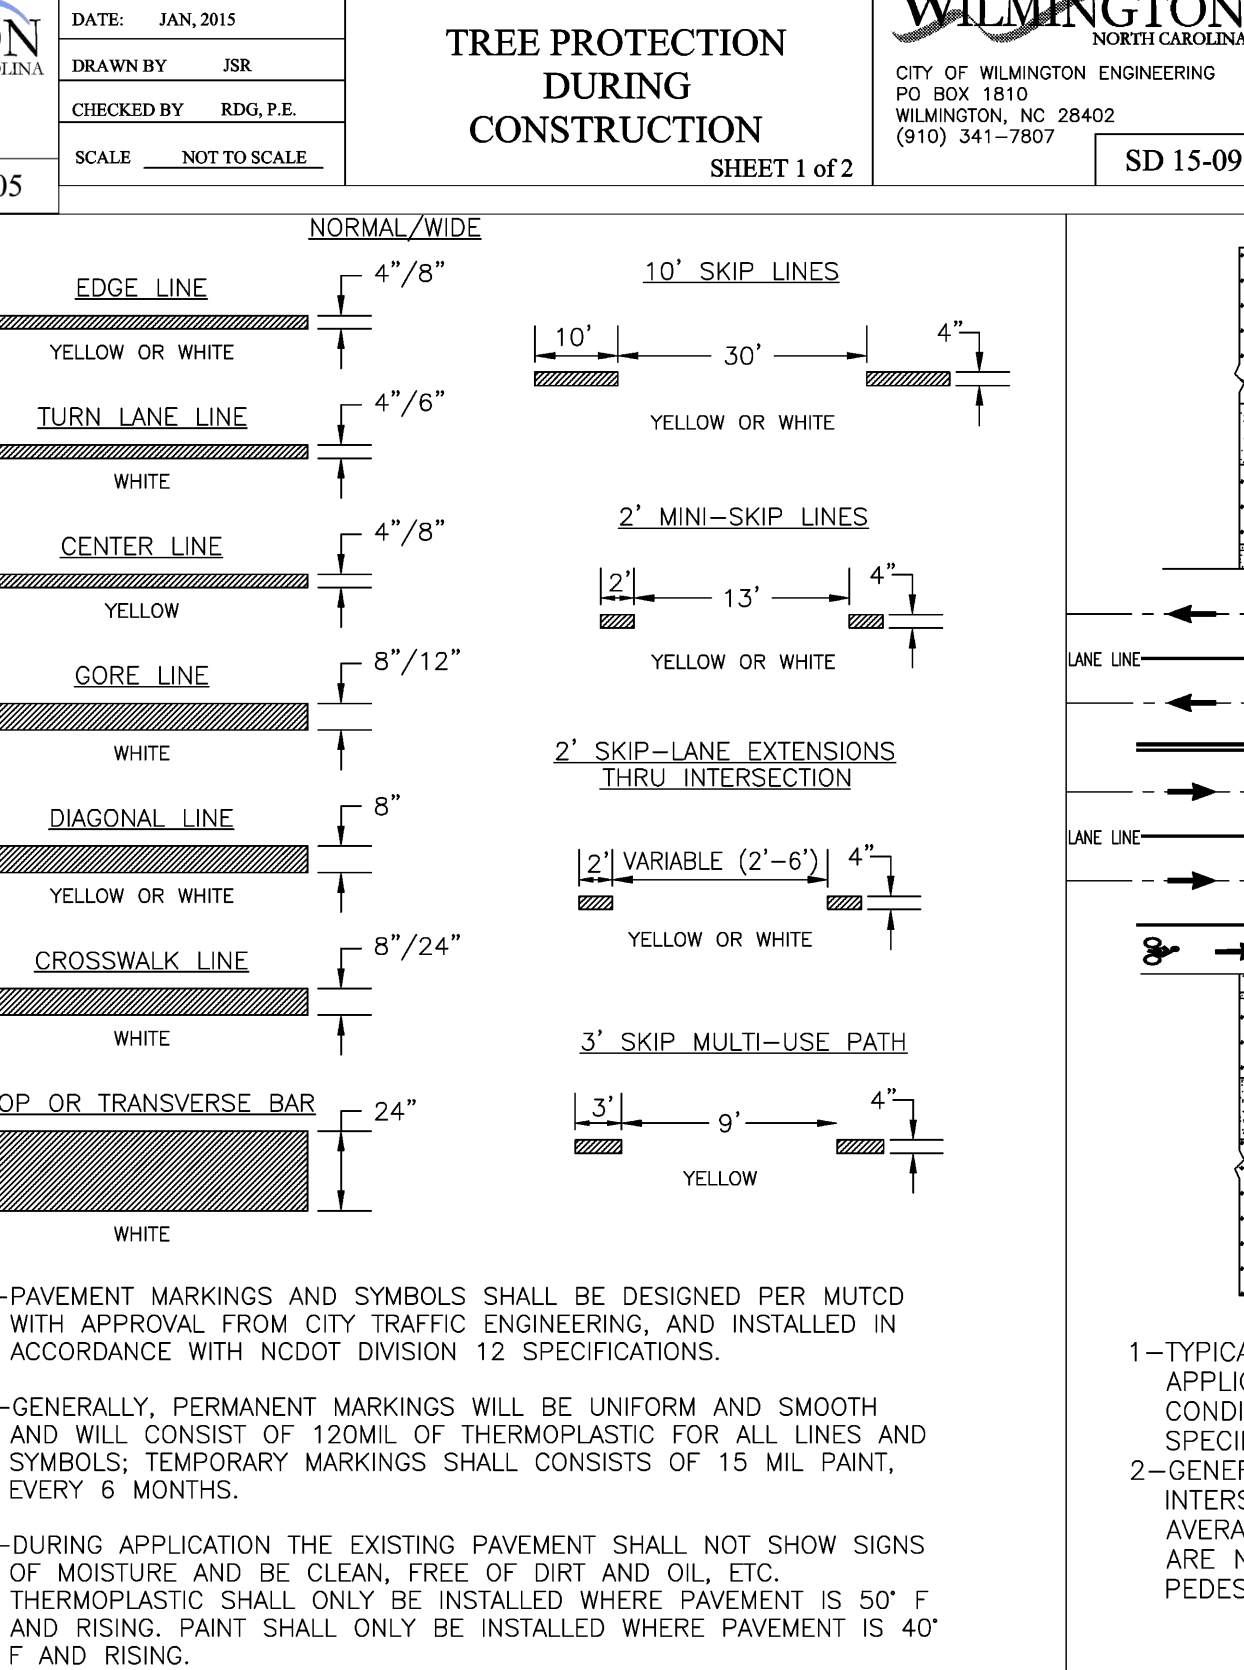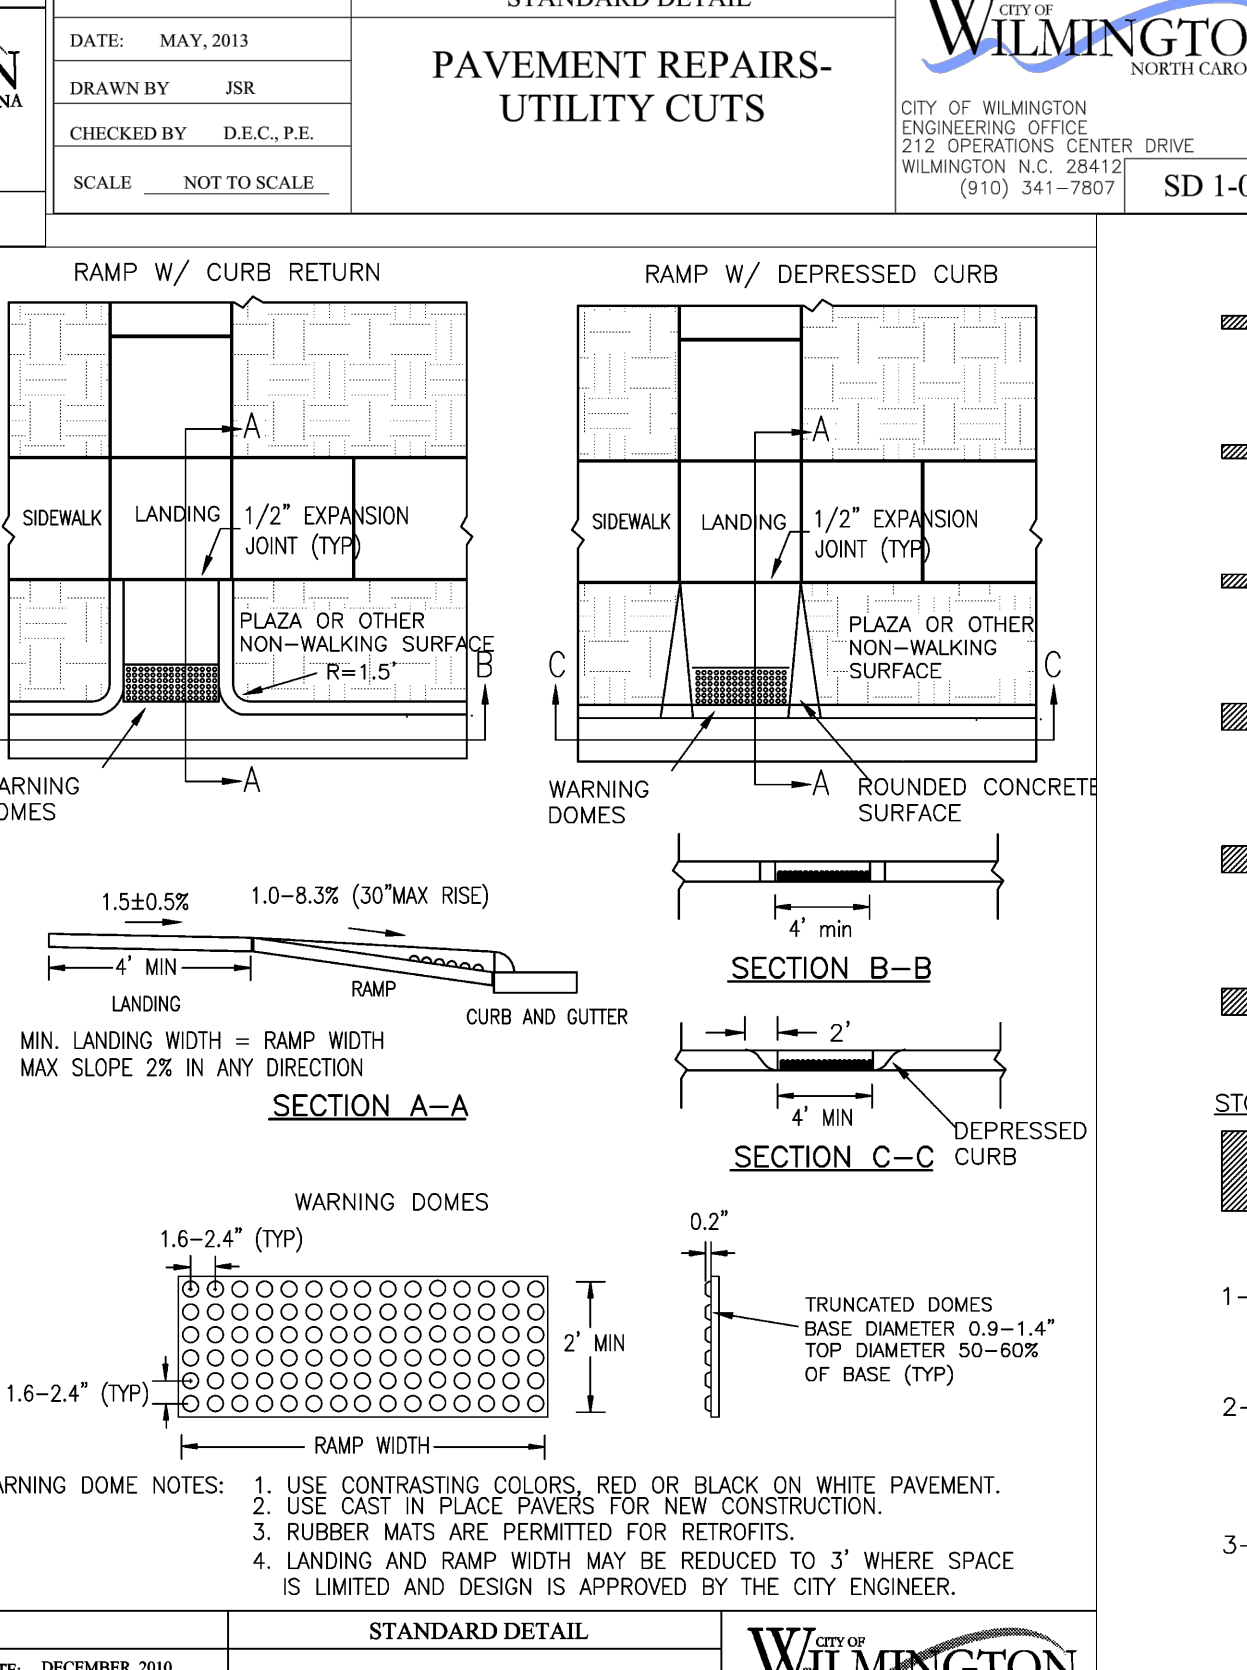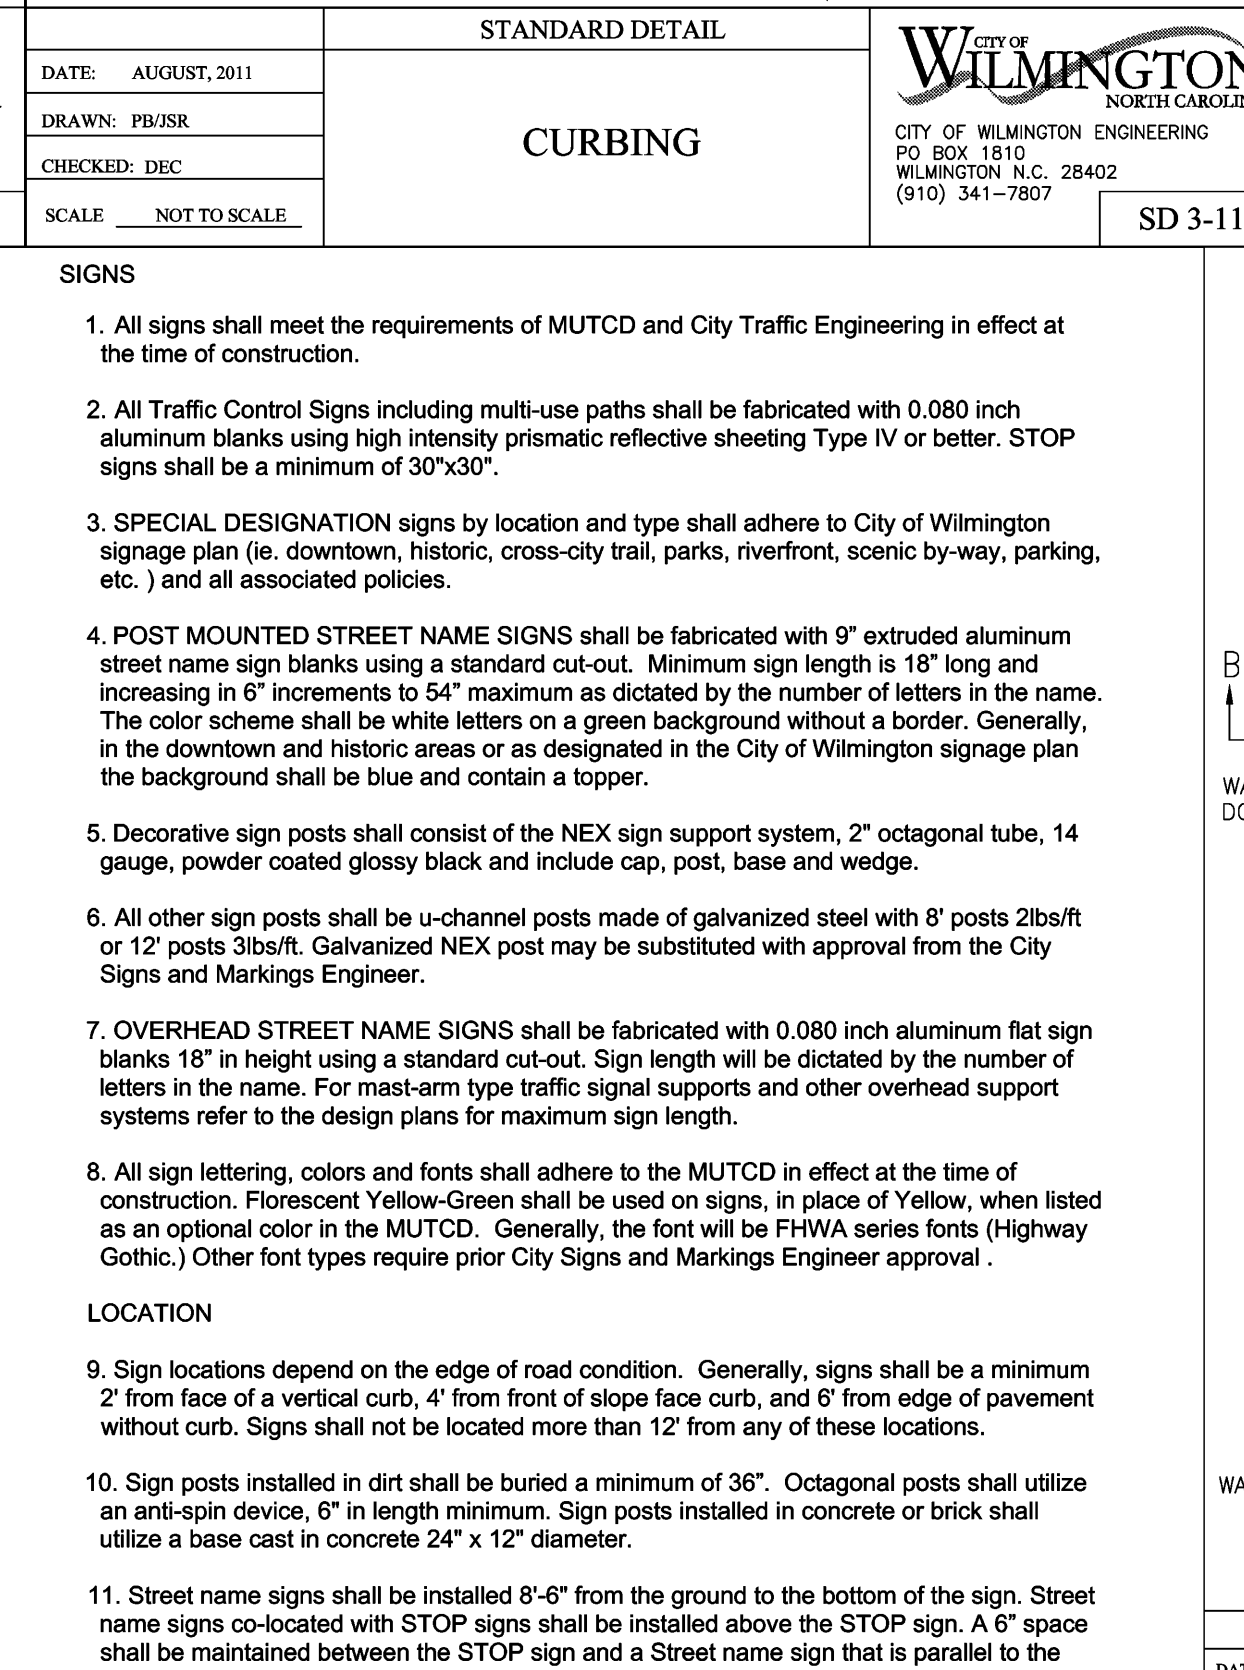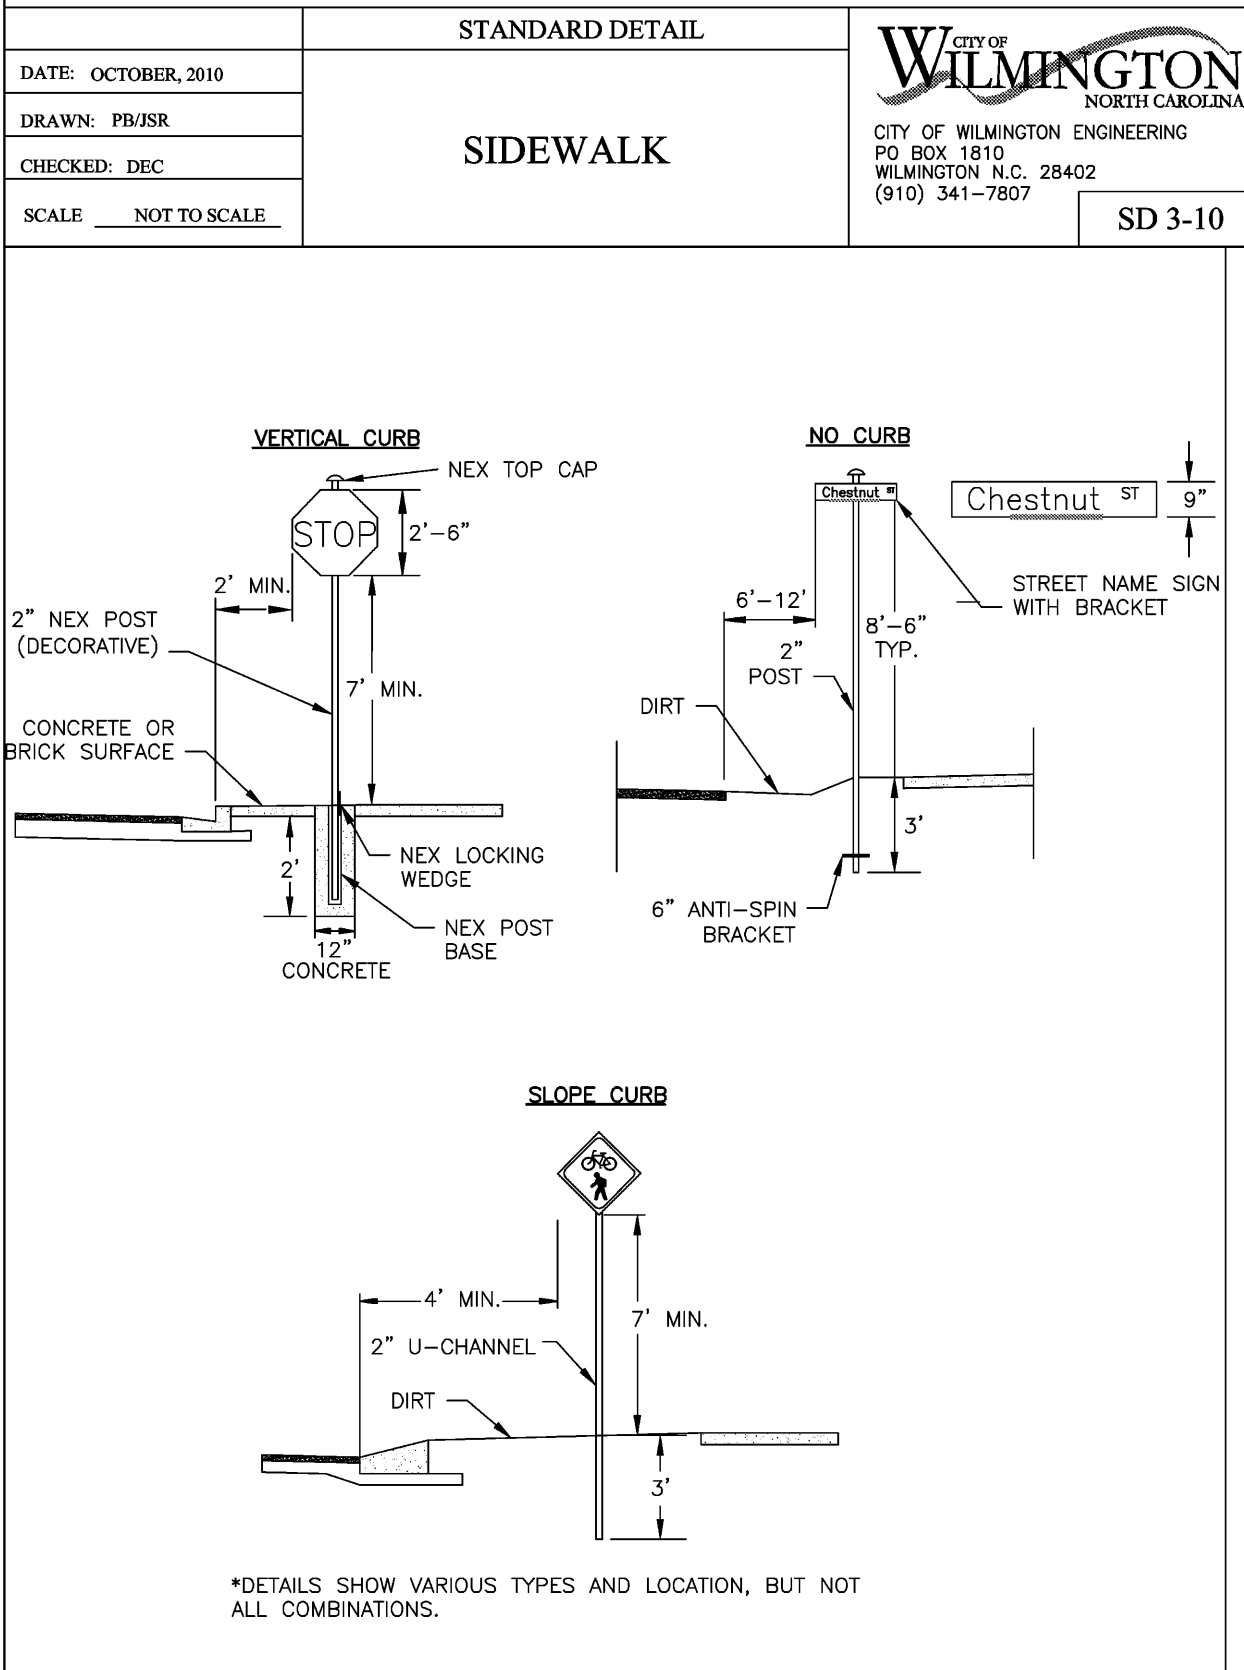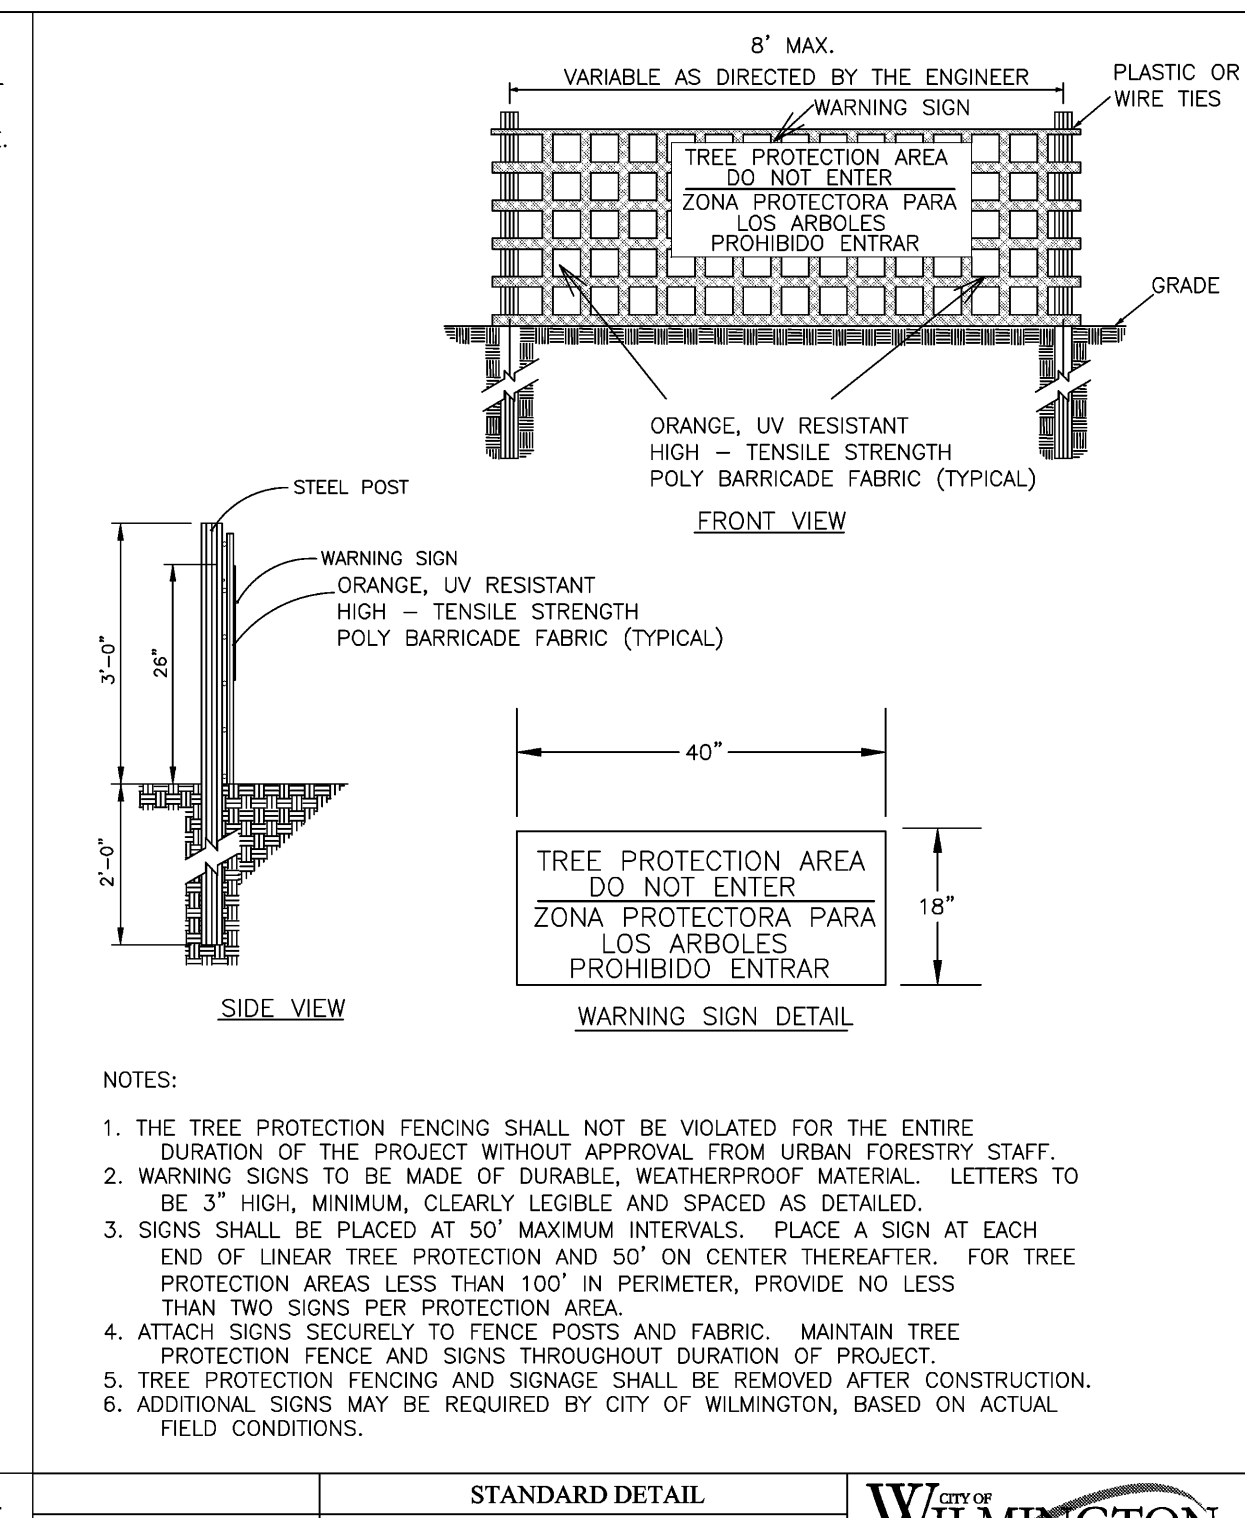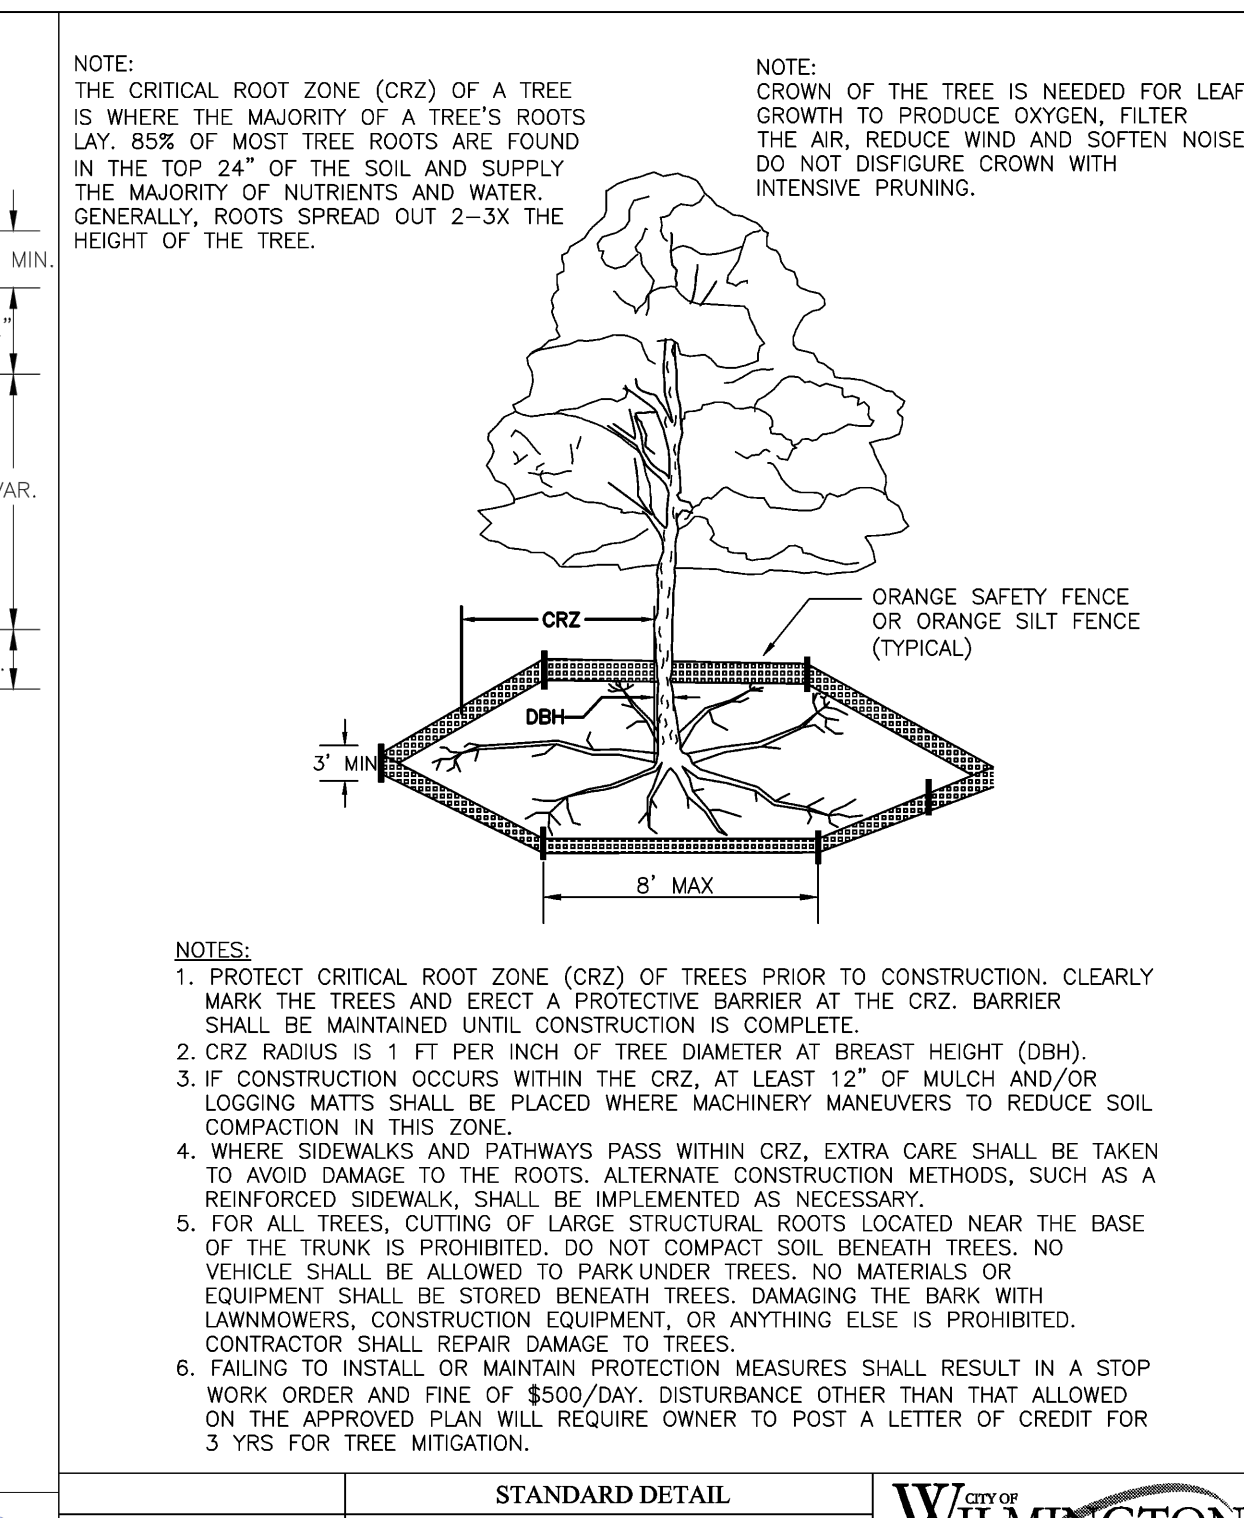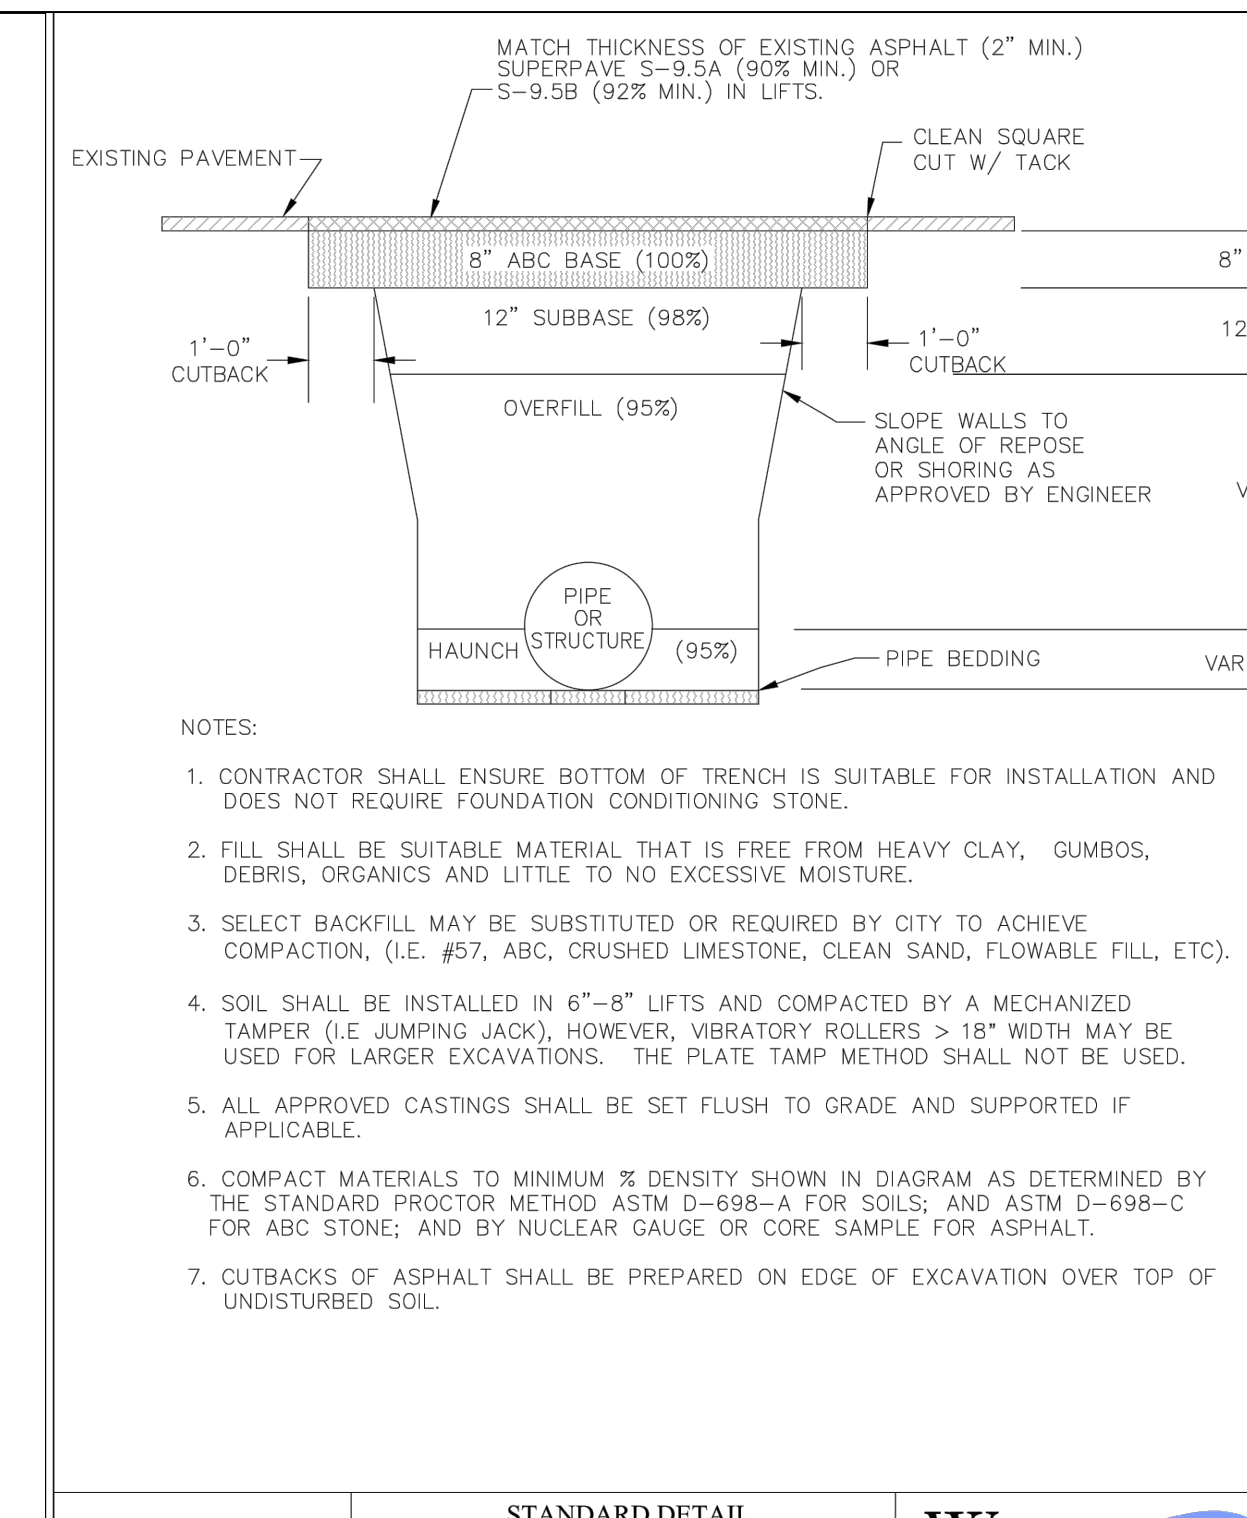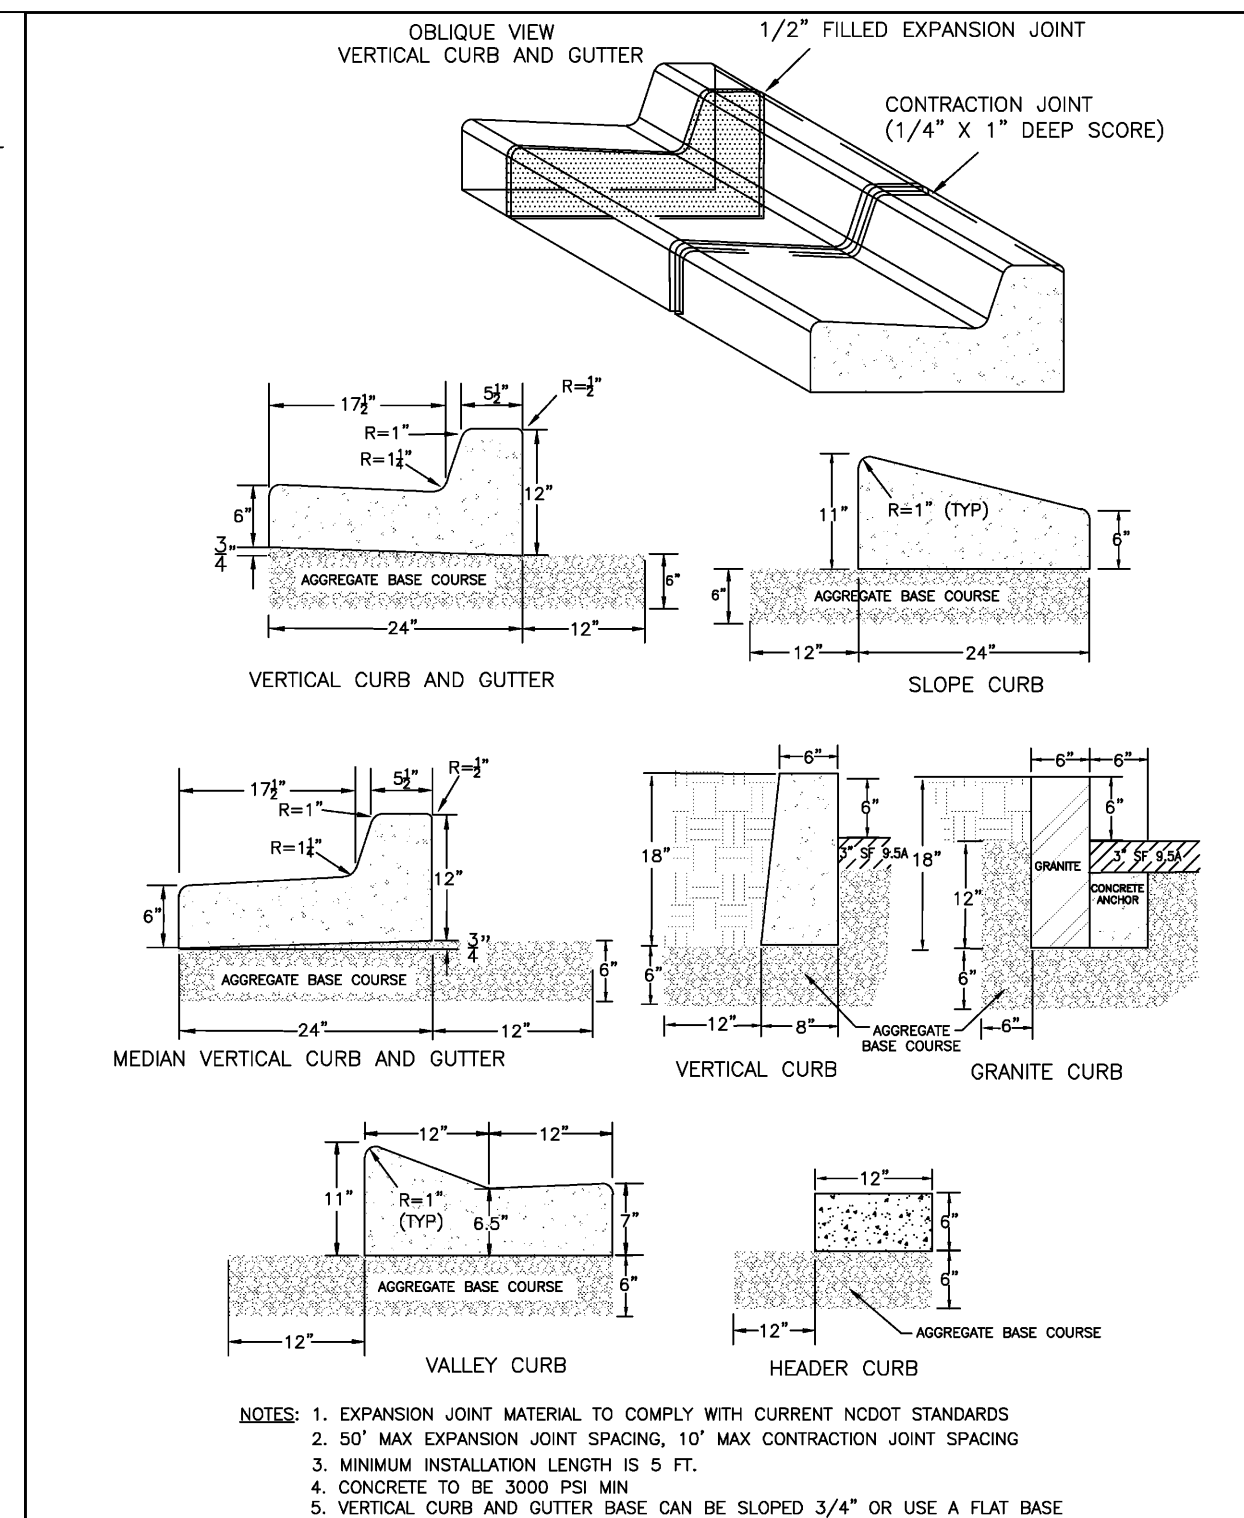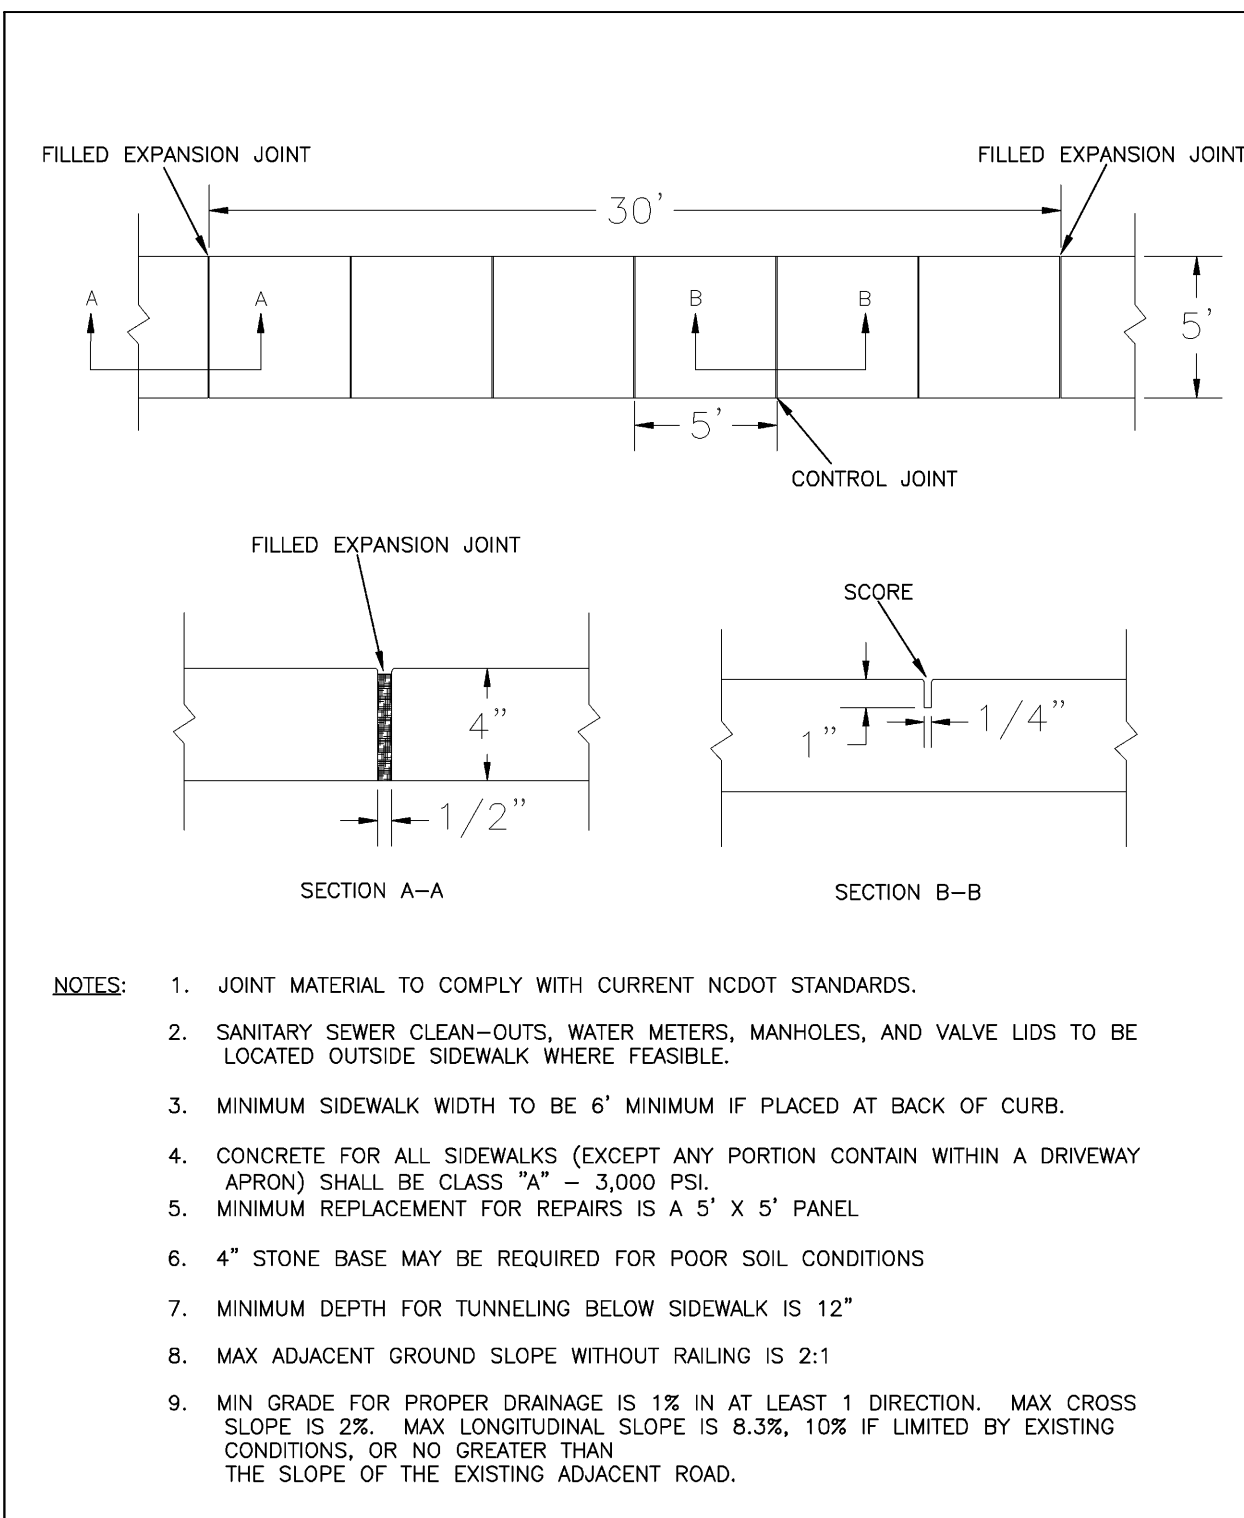

Approved Construction Plan

Name: _____ Date: _____

Planning _____

Traffic _____

Fire _____

Signed: _____


ECHO FARM APARTMENTS
 WILMINGTON TOWNSHIP NEW HANOVER COUNTY NORTH CAROLINA

FINAL DRAWING FOR REVIEW PURPOSES ONLY


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 1134 SHIPYARD BOULEVARD
 WILMINGTON, NORTH CAROLINA 28412
 Phone 910-392-6243
 Fax 910-392-6203 License No. C-2320

Developer: ECHO FARM APARTMENTS, LLC
 10 S. CARDINAL DRIVE
 WILMINGTON, NORTH CAROLINA 28403
 PHONE: 910-251-5030


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 PROJECT NO: 260
 SHEET NO: 16
 OF: 22

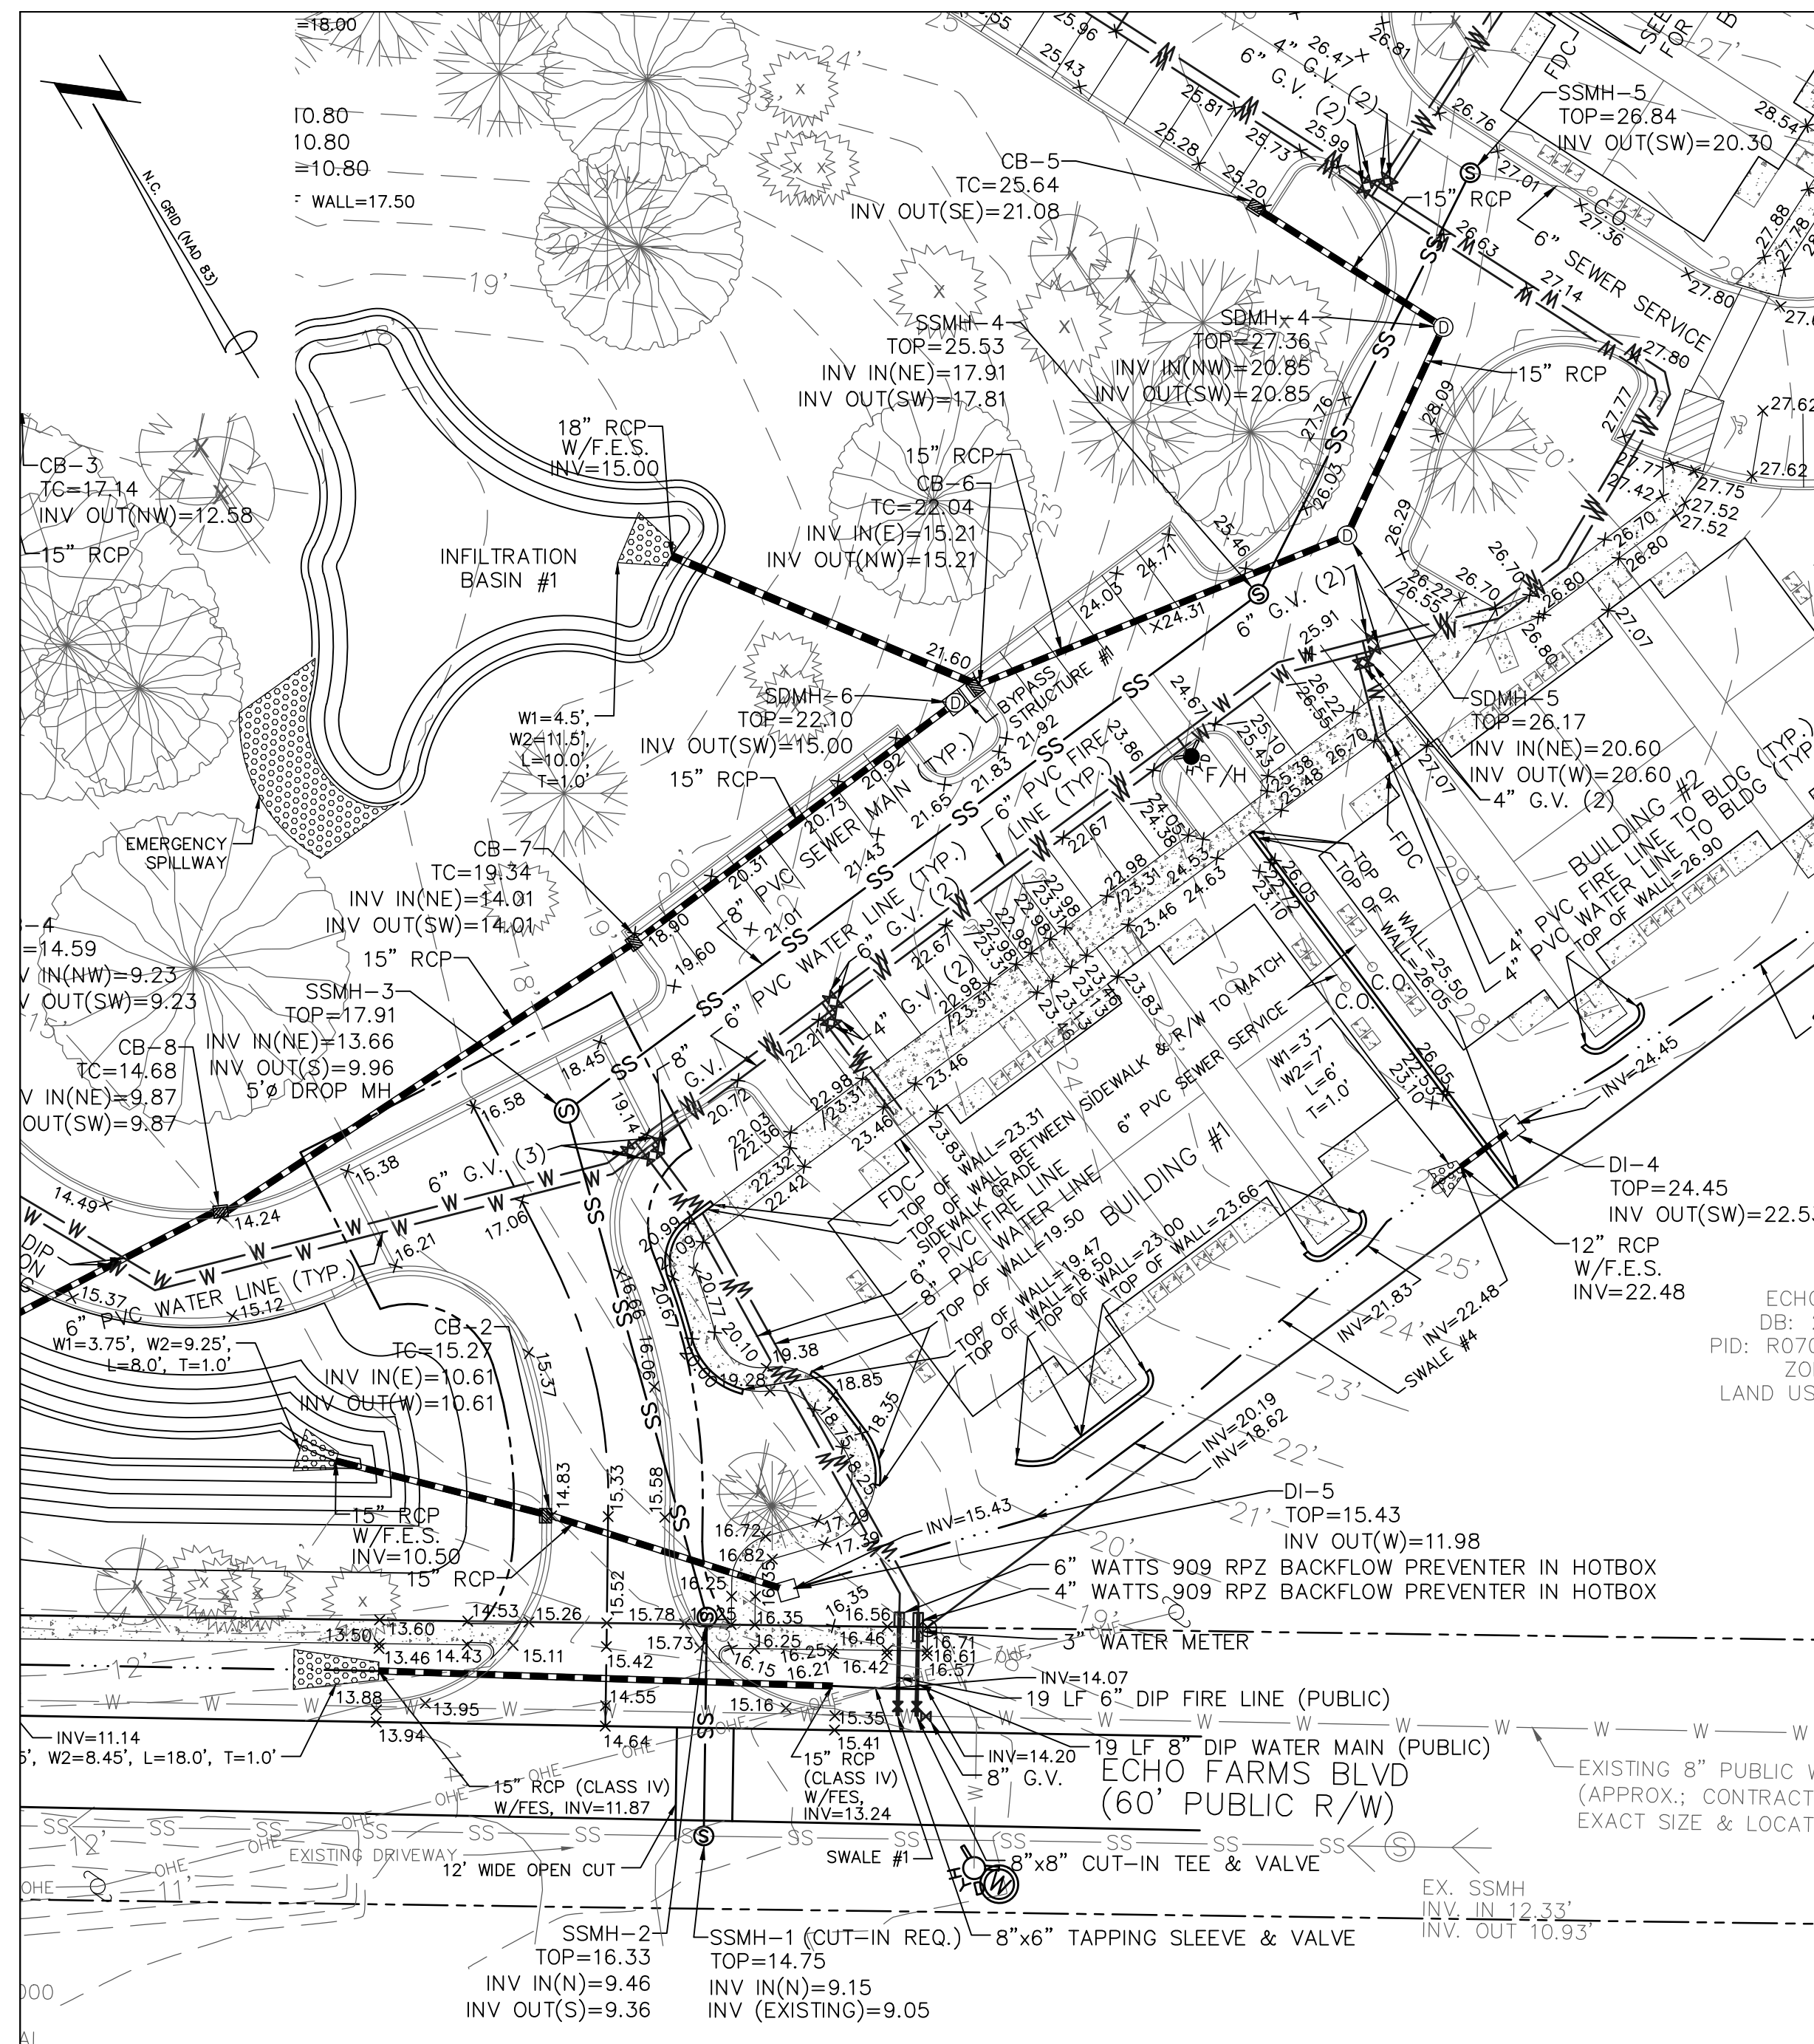


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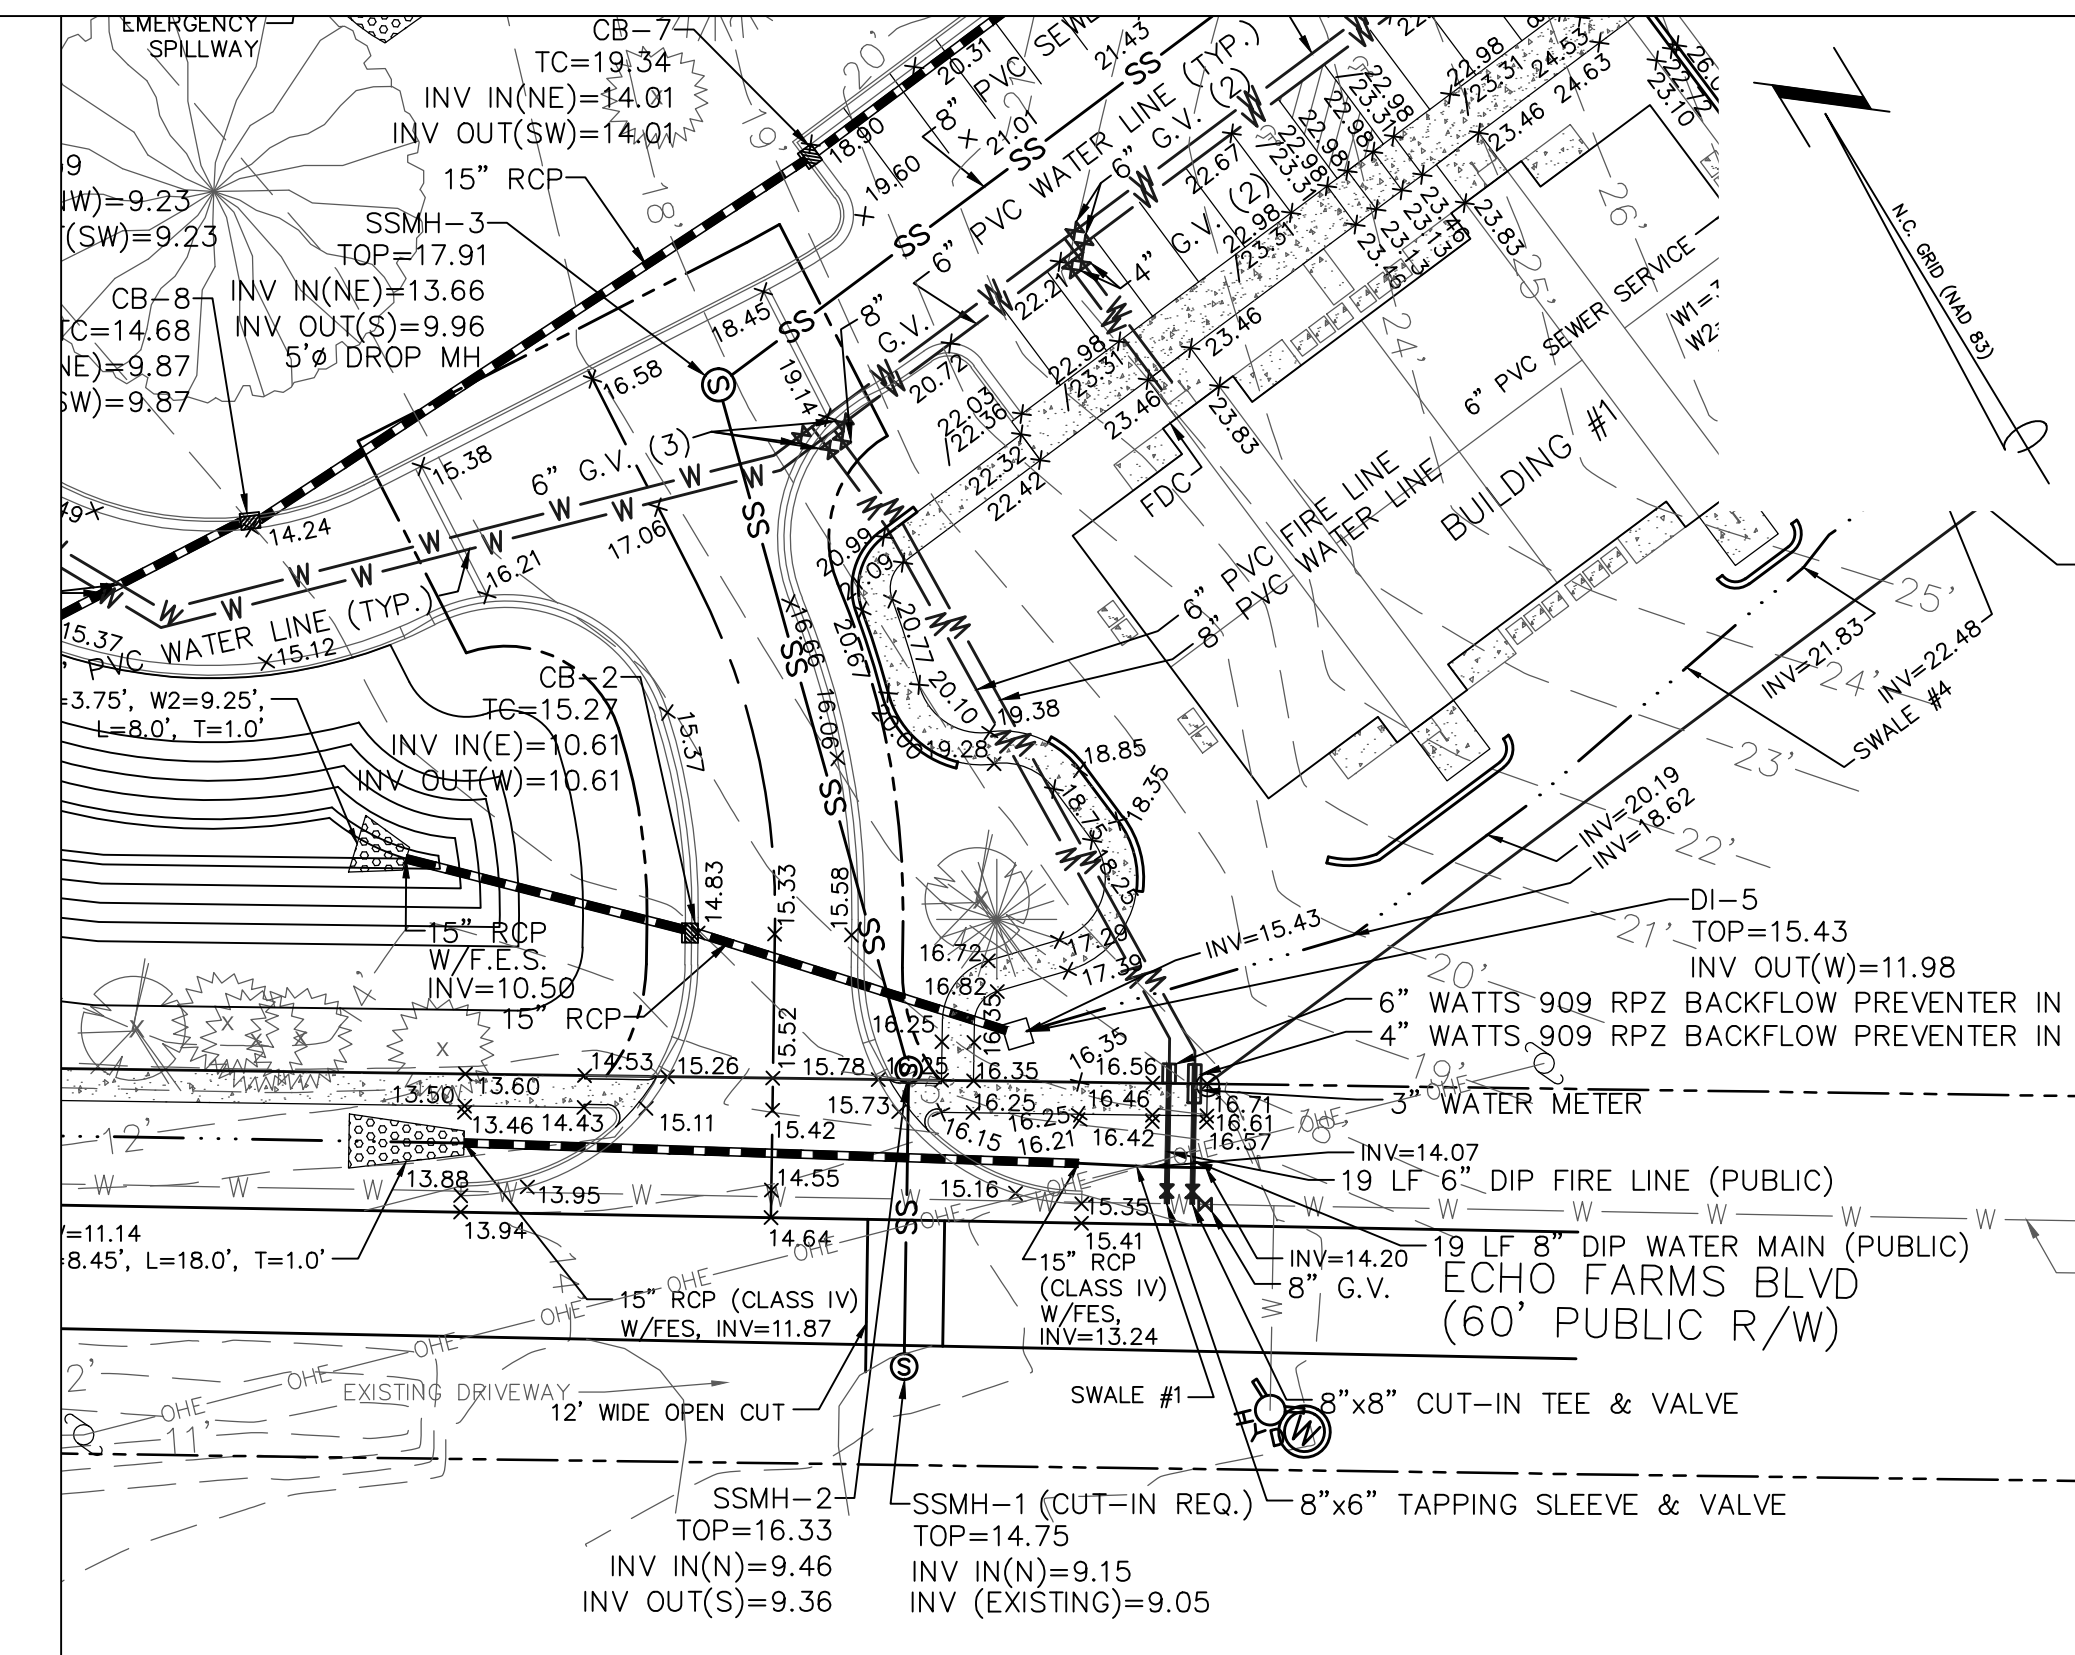
PROFILE SCALE
HORIZONTAL: 1"=50'
VERTICAL: 1"=5'

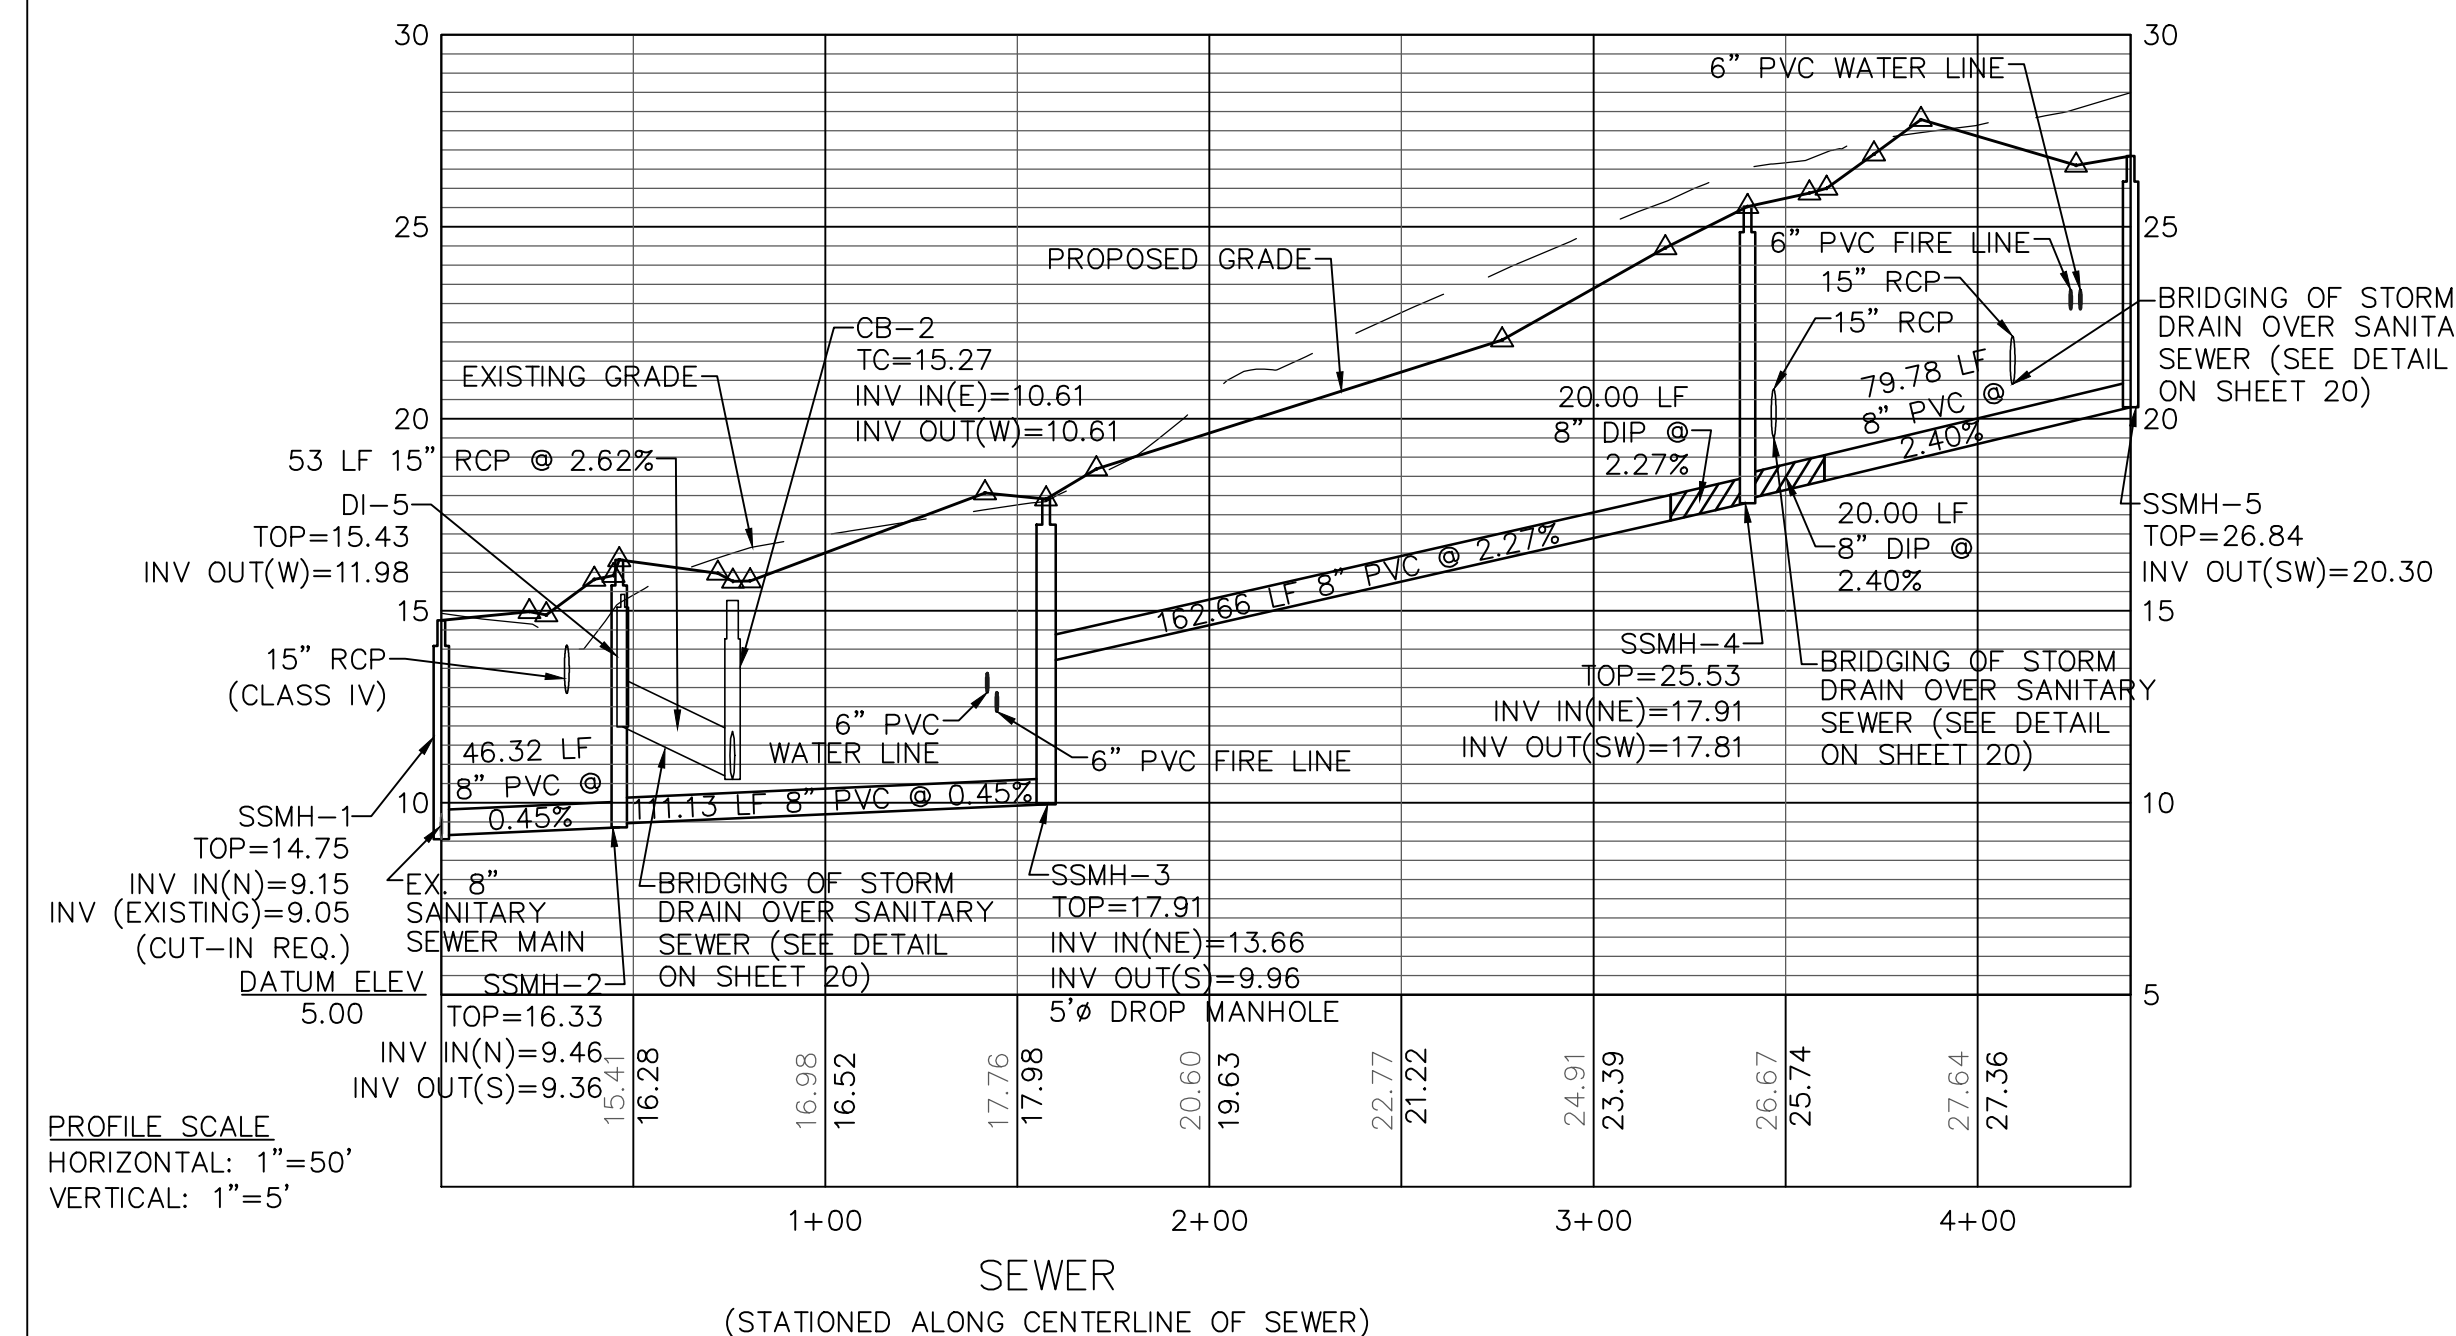


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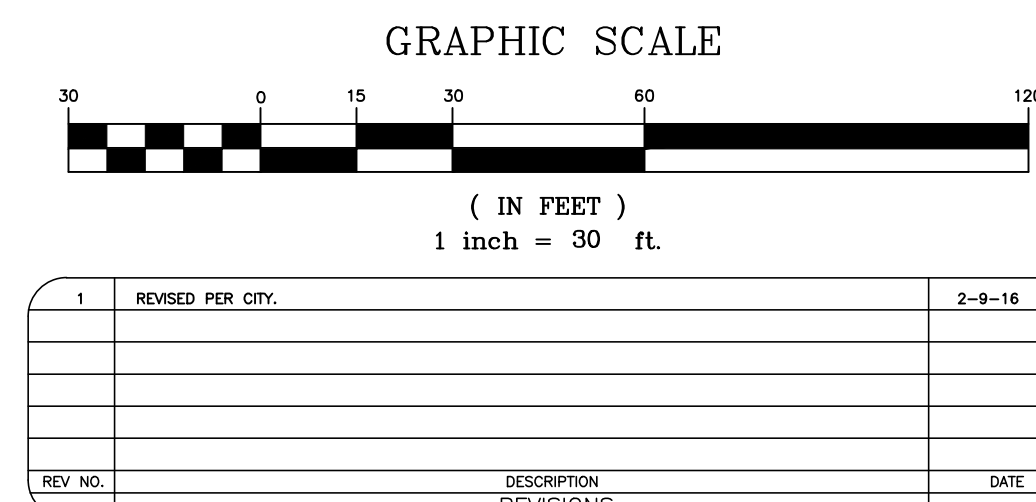
PROFILE SCALE
HORIZONTAL: 1"=50'
VERTICAL: 1"=5'

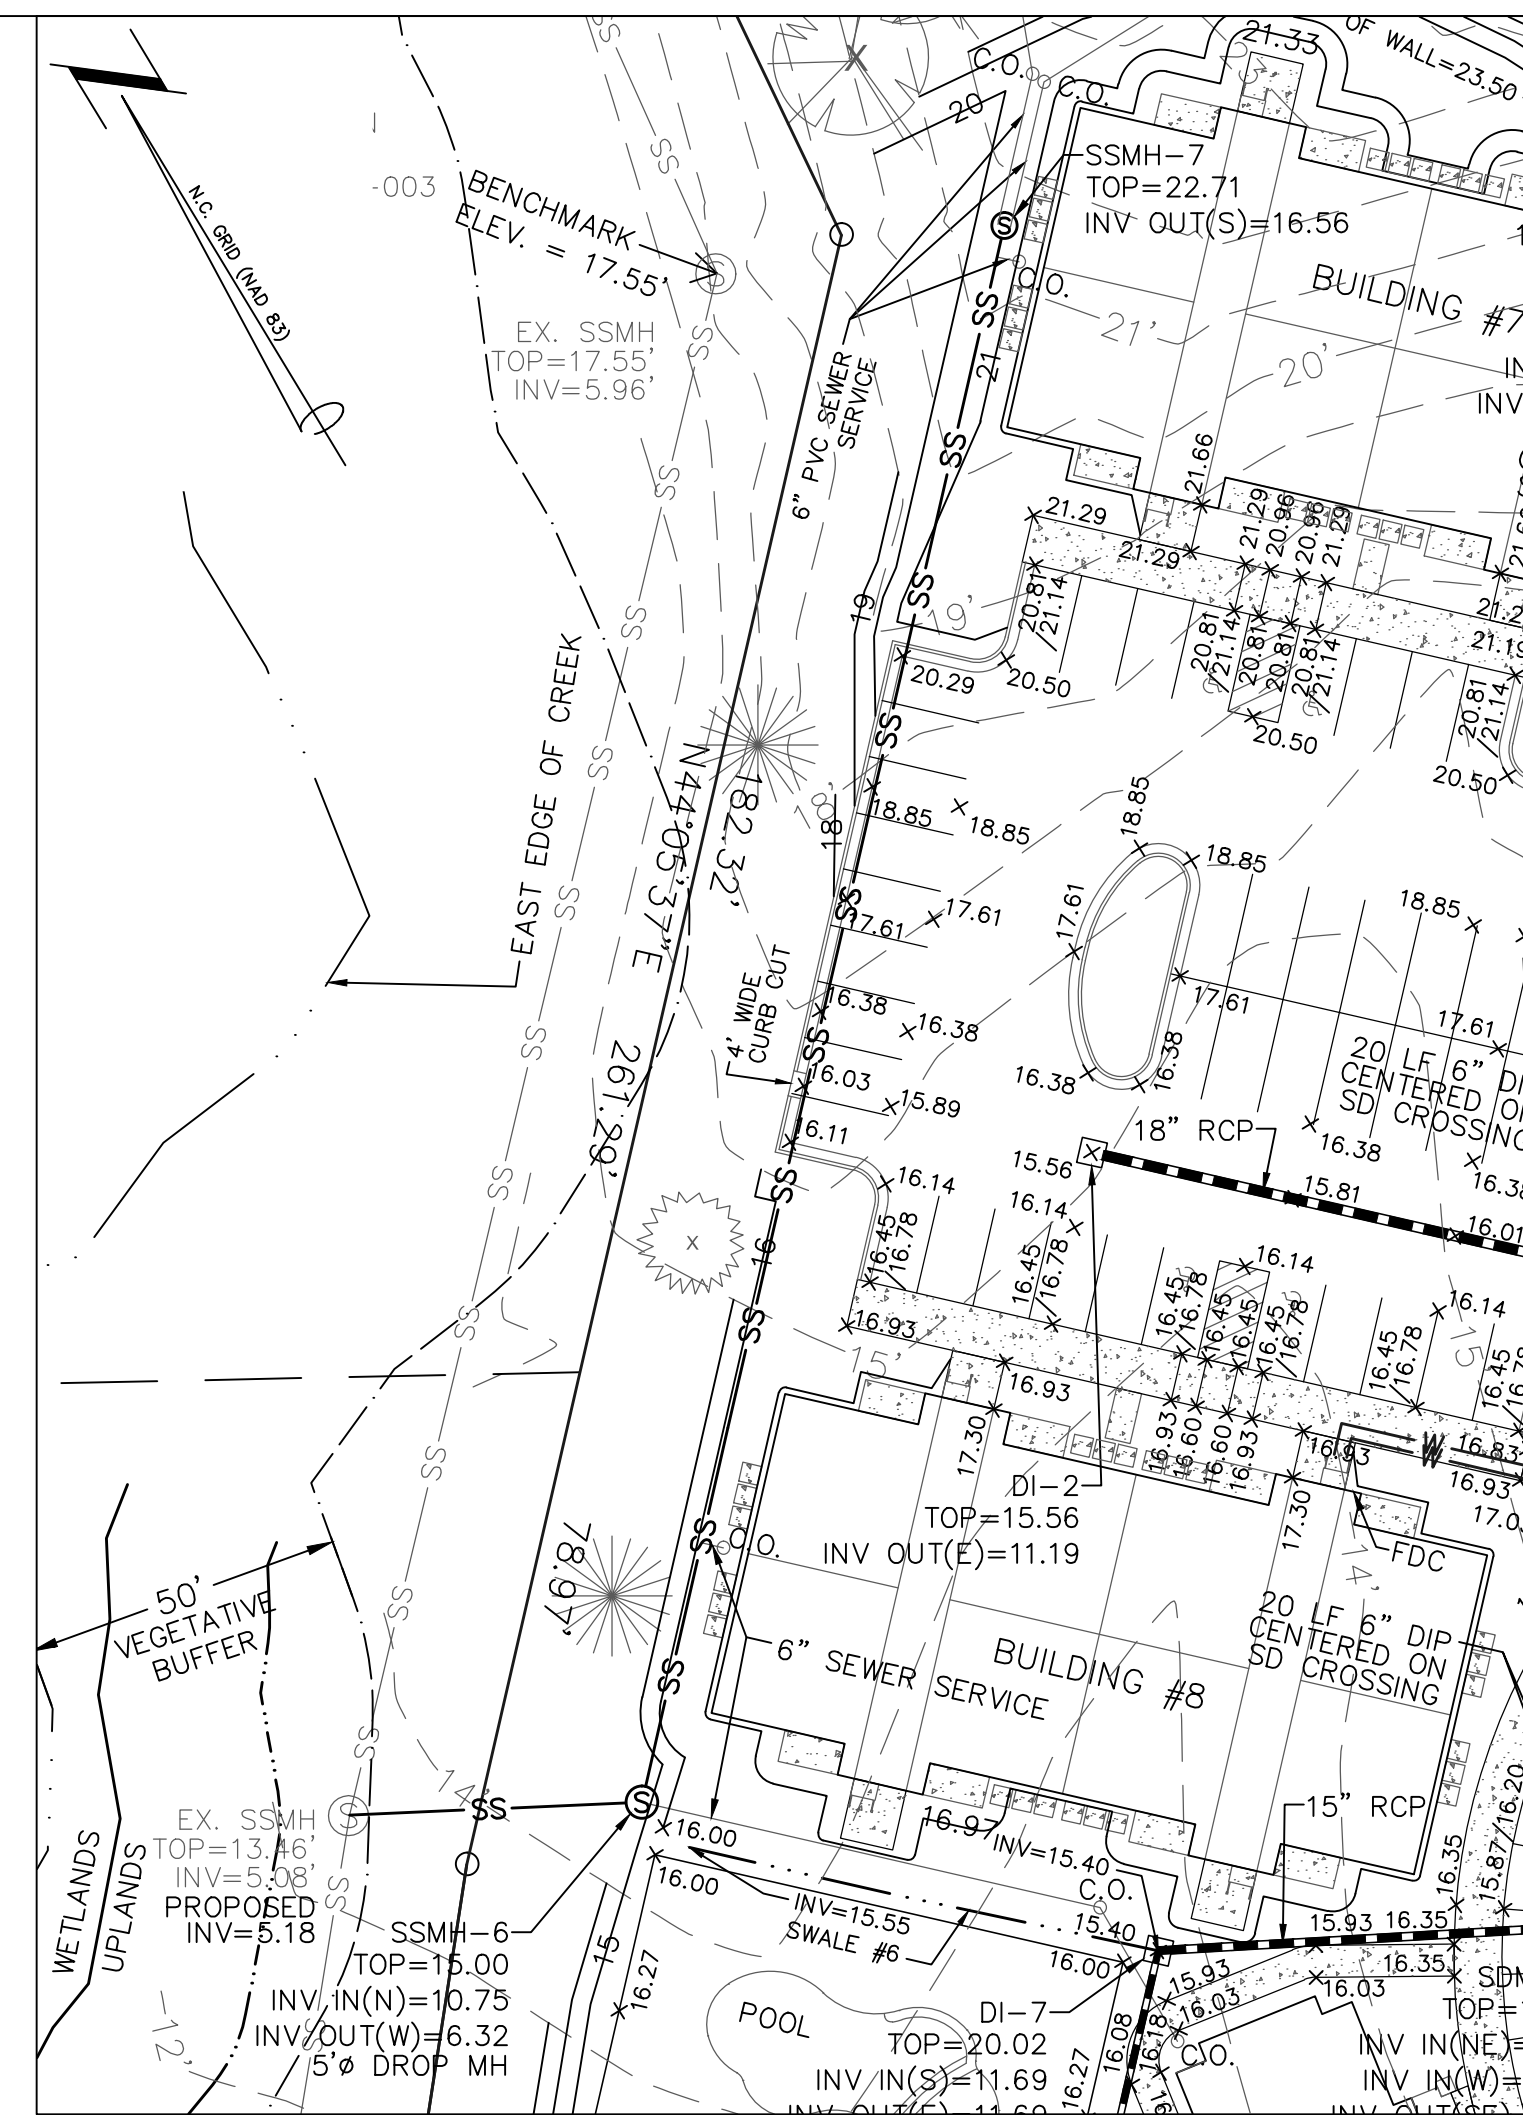

PLAN VIEW SCALE: 1"=30'

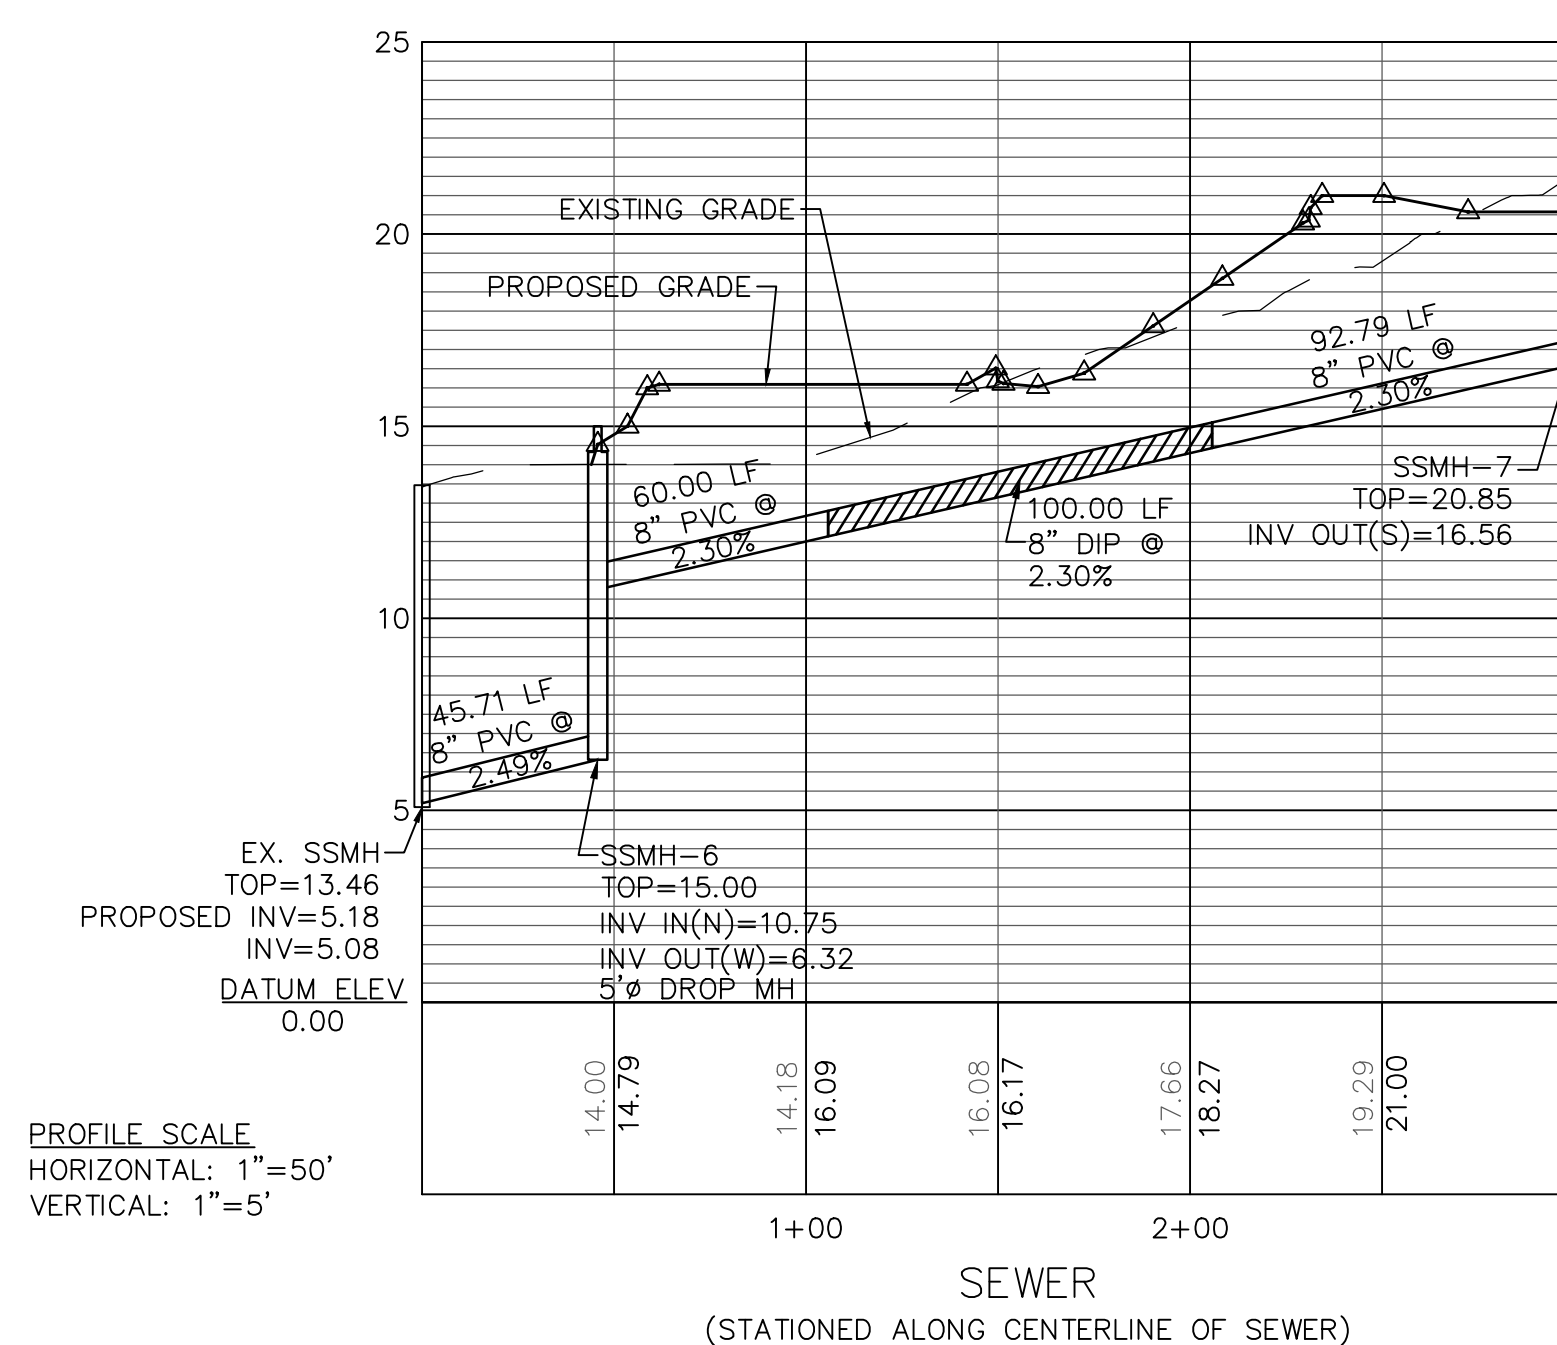

PROFILE SCALE
HORIZONTAL: 1"=50'
VERTICAL: 1"=5'

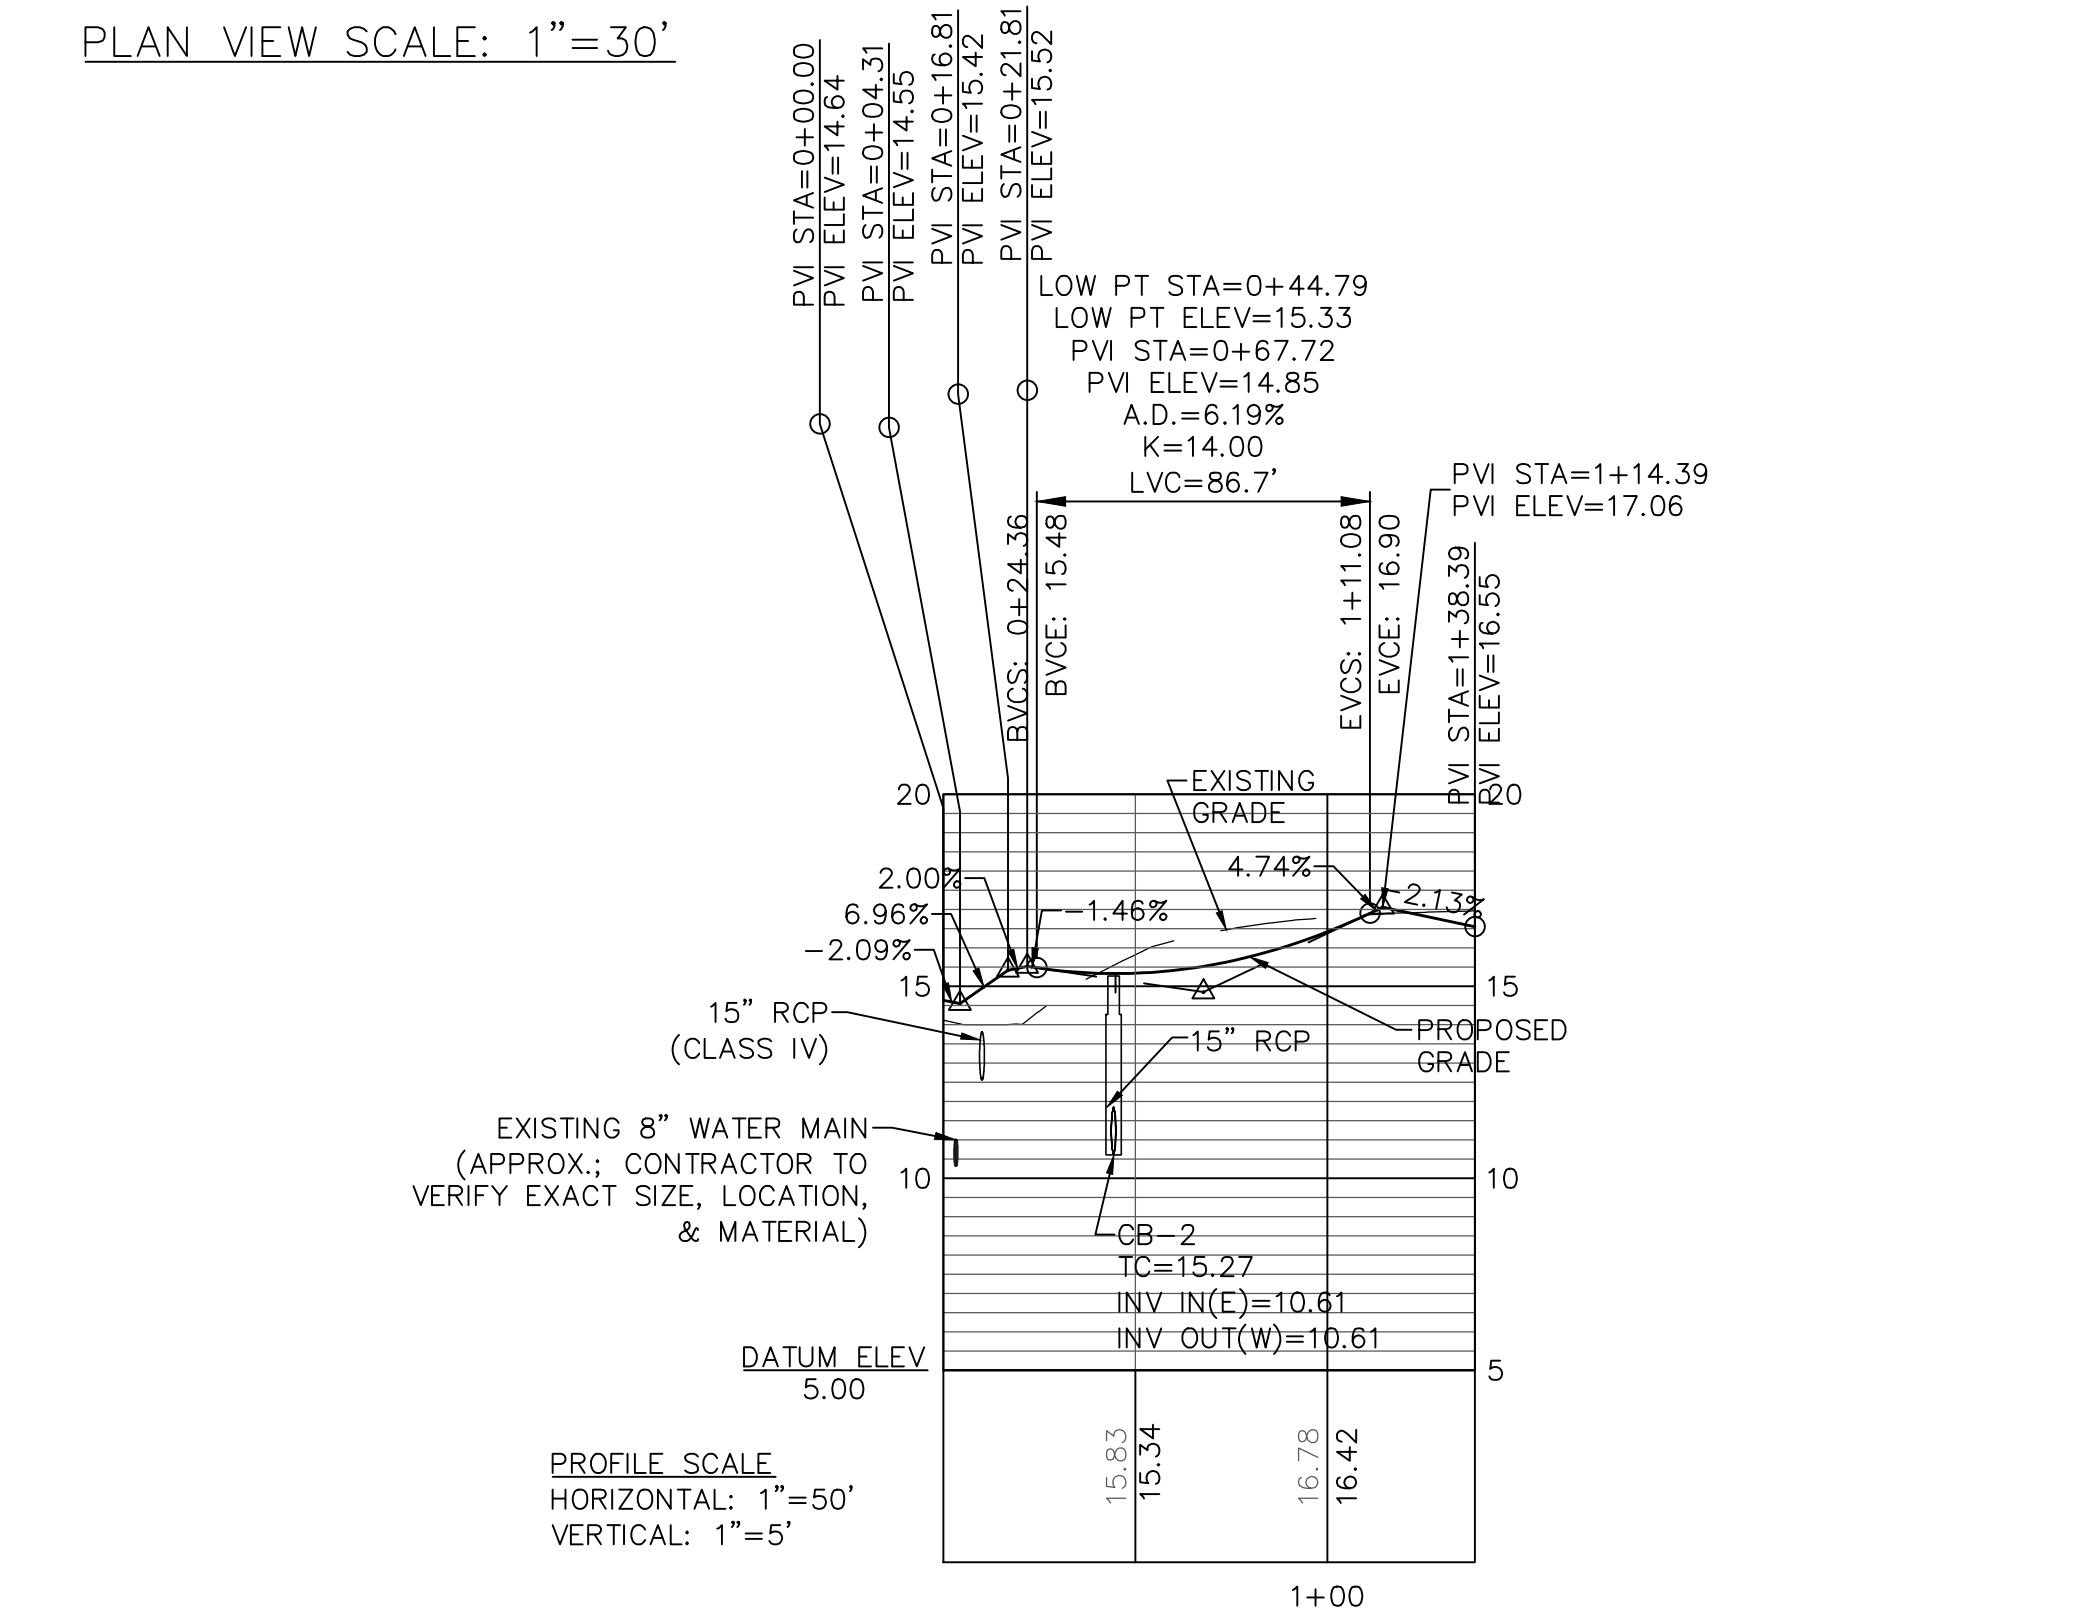

Approved Construction Plan

Name _____ Date _____

Planning _____

Traffic _____

Fire _____

City of WILMINGTON
NORTH CAROLINA
Public Services • Engineering Division
APPROVED STORMWATER MANAGEMENT PLAN
Date: _____ Permit # _____
Signed: _____

PLAN PROFILE
4010 CAROLINA BEACH ROAD
ECHO FARM APARTMENTS
WILMINGTON TOWNSHIP NEW HANOVER COUNTY NORTH CAROLINA

FINAL DRAWING FOR REVIEW PURPOSES ONLY

Developer: ECHO FARM APARTMENTS, LLC
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WILMINGTON, NORTH CAROLINA 28403
PHONE: 910-251-5030

MALPASS ENGINEERING & SURVEYING, P.C.
1134 SHIPYARD BOULEVARD
WILMINGTON, NORTH CAROLINA 28412
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PROJECT NO: 260
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